


© ALL DRAWINGS AND WRITTEN MATERIAL CONTAINED HEREIN ARE THE PROPERTY OF THE LINGLE DESIGN GROUP, INC. THEY MAY NOT BE REVISED, COPIED, REUSED, OR DISCLOSED IN ANY MANNER WITHOUT WRITTEN AUTHORIZATION FROM THE ARCHITECT.

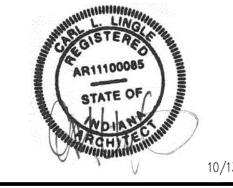

 STATE ID:
 NATIONAL #:

 131246
 40669

 PROJECT #:
 DATE:

 23-287
 10/13/23

#### **REVISIONS**

- 10/13/23 RE-DRAW NEW PROTOTYPE
  11/15/23 QC COMMENTS &
  PROTO UPDATES
- 01/02/24 QC COMMENTS
- 4 01/30/24 CITY COMMENTS
- 02/16/24 ELECTRICAL MARK-UPS

6 03/11/24 - CITY COMMENTS

CLIEN'

# McDonald's USA, LLC

ADDRESS

9521 HAVER WAY (A) INDIANAPOLIS, IN 46240

SHEET TITLE

ROOF PLAN

SHEET NUMBER:

A1.3

SECRETION   SPEC   COMMENTS   SPEC   SPEC   COMMENTS   SPEC   SPEC   SPEC   SPEC   SPEC   SPEC   SPE			FINISH SCHEDULE		
Page   1997			WALL FINISHES		MARK
Part	TAG	DESCRIPTION	SPEC	COMMENTS	100
	2b	WALL PAINT / DOOR FRAMES	BENJAMIN MOORE, 2134-30 IRON MOUNTAIN (SEMI-GLOSS)	RE: DECOR DRAWINGS FOR EXTENT, GC TO PAINT WALL PRIOR TO INSTALLATION OF DECOR.	101
	5d		LAMITECH, GRAPHITE K, MATTE FINISH		102
	6y	RESTROOM WALL TILE	EUROWEST, ARCHITECT FACTORY (12"X24") - GROUT: MAPEI, ULTRACOLOR PLUS FA, CHARCOAL 47	RE: DECOR DRAWINGS FOR EXTENT, CONTACT: MCD CUSTOMER SERVICE AT 800.978.7500 OR MCD@EUROWEST.COM / JAN DETER 714.309.9551	
	6z	RESTROOM ACCENT WALL TILE	EUROWEST, SHELTER BIANCO MATTE (4"X12") - GROUT: MAPEI, ULTRACOLOR PLUS FA, CHARCOAL 47	RE: DECOR DRAWINGS FOR EXTENT, CONTACT: MCD CUSTOMER SERVICE AT 800.978.7500 OR MCD@EUROWEST.COM / JAN DETER 714.309.9551	
March   September   Product Microrally State Book   March	10c	GRAPHIC WALLCOVERING	VARIES		105 106A
So   Septembro	10v	CREW ROOM GRAPHIC WALLCOVERING	DL COUCH, NA-17-MC196 / BX4336 TRUNK SHOW, LIGHT GRAIN	RE: DECOR DRAWINGS FOR EXTENT, CONTACT: MOLLIE BURDETTE, MBURDETTE@MOMTEX.COM, 800.433.0790	106B
March   Marc	20	WALL PANEL	S&D SUPPLIER, LAMINATE - PANOLAM, MCDONALD'S STONE WOOD, TRIM: SATIN ANODIZED ALUMINUM		107
MARKANE   MARK	FRP	FIBERGLASS REINFORCED PANELS	PANOLAM, CLASS A, .075, COLOR: GRAY SMOOTH	1/2" PLYWOOD SUBSTRATE TYP (SEE GENERAL NOTES 4), 1/2" CEMENT BOARD AS NOTED ON SHEET A1.0 CONTACT: KIMBERLY LAWSON 1-866-925-4377 OR KIMBERLY_LAWSON@PANOLAM.COM	109
APPLIED   COUNTY	KB	LAMINATE	LAMITECH, 3156 GREY SLATE		111
MARE OF SERVICE   MARE NO SERVICE   MARK HID - PERSONANCE CRIMENT, WORKER SETTING BEEL LETEX PRICE, AND CERCIT THIS   CONTROL NO MARKER SETTING BEEL LETEX PRICE, AND CERCIT THIS   CONTROL NO MARKER SETTING BEEL LETEX PRICE, AND CERCIT THIS   CONTROL NO MARKER SETTING BEEL LETEX PRICE, AND CERCIT THIS   CONTROL NO MARKER SETTING BEEL LETEX PRICE, AND CERCIT THIS   CONTROL NO MARKER SETTING BEEL LETEX PRICE, AND CERCIT THIS   CONTROL NO MARKER SETTING BEEL LETEX PRICE, AND CERCIT THIS   CONTROL NO MARKER SETTING BEEL LETEX PRICE, AND CERCIT THIS   CONTROL NO MARKER SETTING BEEL LETEX PRICE, AND CERCIT THIS   CONTROL NO MARKER SETTING BEEL LETEX PRICE, AND CERCIT THIS   CONTROL NO MARKER SETTING BEEL LETEX PRICE, AND CERCIT THIS   CONTROL NO MARKER SETTING BEEL LETEX PRICE, AND CERCIT THIS   CONTROL NO MARKER SETTING BEEL LETEX PRICE, AND CERCIT THIS   CONTROL NO MARKER SETTING BEEL LETEX PRICE, AND CERCIT THIS   CONTROL NO MARKER SETTING BEEL LETEX PRICE, AND CERCIT THIS   CONTROL NO MARKER SETTING BEEL MORTH SETTING BEEL MORTH SETTING BEEL MORTH SETTING BEEL MORTH SETTING BEEN M	KF	GRAPHIC WALLCOVERING	S&D SUPPLIER, BALTIC BIRCH	RE: DECOR DRAWINGS FOR EXTENT, G.C. TO PREP WALL PER FINISH PLAN NOTES. SEE INSTALL INSTRUCTIONS FOR MORE INFORMATION.	112
March   DESCRIPTION   SPEC   SUMBLY   PESTROOR FLOW   SPEC   SUMBLY   SUMBLY   PESTROOR FLOW   SPEC   SUMBLY	WT2	KITCHEN WALL TILE	MAPEI 02 PEWTER - JOINT TO BE 1/16" MAX. HIGH PERFORMANCE CEMENT, MORTAR SETTING BED: LATEX-PORTLAND CEMENT THIN		113
Total   Source   Restriction Floor Tile   Europest, urban dove (247x8f) - Base: (FELD CUT NTO 4" PECES, U.N.O.) - GROUT MAPEL, ULTRACOCOR PLUS FA, IRON 107 17, ASD, 9651   See Streom Base   Schulter Systams p. Dilex-Airk-15-125-AL, SAIN ANDOZED ALUMINUM   RE-DEBUTE STREAM PROVED PROVINCE					115
Fig.   September	TAG	DESCRIPTION	SPEC		116
RESINDON BASE   SCHULER STOLLES P. DILLX-ANT-S-12-2-2. ASIN AND CED ALDMINON   RESIDED BANKS FOR EXION, CONTACT: EARL MAILUS SOUZ-/GREY F.S. 340   RESIDED BANKS FOR EXION, CONTACT: EARL MAILUS SOUZ-/GREY F.S. 340   RESIDE BANKS FOR EXION, CONTACT: EARL MAILUS SOUZ-/GREY F.S. 340   RESIDE BANKS FOR EXION, CONTACT: EARL MAILUS SOUZ-/GREY F.S. 340   RESIDE BANKS FOR EXION, CONTACT: EARL MAILUS SOUZ-/GREY F.S. 340   RESIDE BANKS FOR EXION, CONTACT: EARL MAILUS SOUZ-/GREY F.S. 340   RESIDE BANKS FOR EXION, CONTACT: EARL MAILUS SOUZ-/GREY F.S. 340   RESIDE BANKS FOR EXION, CONTACT: EARL MAILUS SOUZ-/GREY F.S. 340   RESIDE BANKS FOR EXION F.S. 340   RESIDE BANKS FOR EXION F.S. 340	<b>7</b> a	DINING / RESTROOM FLOOR TILE	EUROWEST, URBAN DOVE (24"X48") - BASE: (FEILD CUT INTO 4" PIECES, U.N.O.) - GROUT: MAPEI, ULTRACOLOR PLUS FA, IRON 107	(SEE GENERAL NOTE 2), RE: DECOR DRAWINGS FOR EXTENT, CONTACT: MCD CUSTOMER SERVICE AT 800.978.7500 OR MCD@EUROWEST.COM / JAN DETE  714.309.9551	117
B1 NICHEN BASE IILE ACM, GROUT. KERRADY IEC BLACK, 960 BY MAPE, CHARCOLAL PAT BY MAPE, (CHARCOLAL PAT BY MAPE) (FOR COTIONAL BED IILE) CHEMICAL RESISTANT, WATER-CHARBE, INJECTING PEDY - 100% SOLUS, INDUSTRIAL-GRACK, MORTAR SETTING BED: MODIFIED-PORTLAND CEMENT THIN SET URDITAR (MEDIUM BED)  WALK-IN COCLER/FREEZER BASE A* ALMANIMA COMED BASE  AVAILABILE INJECTION OF THE CHARCOLAL PAT BY MAPE, CHARCOLAL PAT BY M	9b	RESTROOM BASE	SCHLUTER SYSTEMS LP, DILEX-AHK-1S-125-AE, SATIN ANODIZED ALUMINUM	RE: DECOR DRAWINGS FOR EXTENT, CONTACT: EARL MAICUS: 800.267.0817 EXT. 3410	118
CROSSVILLE - METROPOLITAN QUARRY BASICS ABRASIVE (6"%6"), COLOR: PURITAN GRAY EXTRA ABRASIVE 57XA (STANDARD), MAYELOWER RED 31XA (O'RTIONAL) - VERIFY MY MCDONALD'S AGUA; (ROUT: KERAPOXY - 100% SQUDS, INDUSTRIAL-GRADE, MAYELOWER RED 31XA (O'RTIONAL) - VERIFY MY MCDONALD'S AGUA; (ROUT: KERAPOXY - 100% SQUDS, INDUSTRIAL-GRADE, MORTAR SETTING BD: MODIFIED-PORTLAND CEMENT THIN SET MORTAR (MEDIUM BED)  ***MORTAR SETTING BD: MODIFIED-PORTLAND CEMENT THIN SET MORTAR (MEDIUM BED)  ***MORTAR SETTING BD: MODIFIED-PORTLAND CEMENT THIN SET MORTAR (MEDIUM BED)  ***MORTAR SETTING BD: MODIFIED-PORTLAND CEMENT THIN SET MORTAR (MEDIUM BED)  ***MORTAR SETTING BD: MODIFIED-PORTLAND CEMENT THIN SET MORTAR (MEDIUM BED)  ***MORTAR SETTING BD: MODIFIED-PORTLAND CEMENT THIN SET MORTAR (MEDIUM BED)  ***MORTAR SETTING BD: MODIFIED-PORTLAND CEMENT THIN SET MORTAR (MEDIUM BED)  ***MORTAR SETTING BD: MODIFIED-PORTLAND CEMENT THIN SET MORTAR (MEDIUM BED)  ***MORTAR SETTING BD: MODIFIED-PORTLAND CEMENT THIN SET MORTAR (MEDIUM BED)  ***MORTAR SETTING BD: MODIFIED-PORTLAND CEMENT THIN SET MORTAR (MEDIUM BED)  ***MORTAR SETTING BD: MODIFIED-PORTLAND CEMENT THIN SET MORTAR (MEDIUM BED)  ***MORTAR SETTING BD: MODIFIED-PORTLAND CEMENT THIN SET MORTAR (MEDIUM BED)  ***MORTAR SETTING BD: MODIFIED-PORTLAND CEMENT THIN SET MORTAR (MEDIUM BED)  ***MORTAR SETTING BD: MODIFIED-PORTLAND CEMENT THIN SET MORTAR (MEDIUM BED)  ***MORTAR SETTING BD: MODIFIED-PORTLAND CEMENT THIN SET MORTAR (MEDIUM BED)  ***MORTAR SETTING BD: MODIFIED-PORTLAND CEMENT THIN SET MORTAR (MEDIUM BED)  ***MORTAR SETTING BD: MODIFIED-PORTLAND CEMENT THIN SET MORTAR (MEDIUM BED)  ***MORTAR SETTING BD: MODIFIED-PORTLAND CEMENT THIN SET MORTAR (MEDIUM BED)  ***MORTAR SETTING BD: MODIFIED-PORTLAND CEMENT THIN SET MORTAR (MEDIUM BED)  ***MORTAR SETTING BD: MORTAR SET	B1	KITCHEN BASE TILE	ACM, GROUT: KERAPOXY IEG BLACK #10 BY MAPEI, CHARCOAL #47 BY MAPEI (FOR OPTIONAL RED TILE) CHEMICAL RESISTANT, WATER-CLEANABLE, TILE-SETTING EPOXY - 100% SOLIDS, INDUSTRIAL-GRADE, MORTAR SETTING BED: MODIFIED-PORTLAND CEMENT	CONTACT: MCD CUSTOMER SERVICE AT 800.978.7500 OR MCD@EUROWEST.COM / JAN DETER 714.309.9551	
MAYFLOWER RED 3TXA (OPTIONAL) — NEIFIFY MY MCDONALDS ACM, GROUT, SERRONX FEG BLACK #10 BY MAPFL, CHARCOAL # 71 BY MAPFL (FOR ORDINAL RED TILLS) — CONTACT: MCD CUSTOMER SERVICE AT 800.978.7500 OR MCDØEUROWEST.COM / JAN DETER 714.309.9551  MORTAR SETTING BED: MODIFIED—PORTLAND CEMENT THIN SET MORTAR (MEDIUM BED)  TAG DESCRIPTION SPEC COMMENTS  DINING ROOM TOP CAPS / DUPONT, CORIAN, CAMEO WHITE  DINING ROOM TOP CAPS / DUPONT, CORIAN, CAMEO WHITE  DINING ROOM TOP CAPS / DUPONT, CORIAN, CAMEO WHITE  DINING ROOM TOP CAPS / DUPONT, CORIAN, DEEP MINK  PE: DECOR DRAWINGS FOR EXTENT, CONTACT: ERIN FAIRFIELD, ERINMICHELLE.FAIRFIELD@UPONT.COM, 612.499.4875  DIVING ROOM TOP CAPS / DUPONT, CORIAN, DEEP MINK  PE: DECOR DRAWINGS FOR EXTENT, CONTACT: ERIN FAIRFIELD, ERINMICHELLE.FAIRFIELD@UPONT.COM, 612.499.4875  DIVING ROOM TOP CAPS / DUPONT, CORIAN, DEEP MINK  PE: DECOR DRAWINGS FOR EXTENT, CONTACT: ERIN FAIRFIELD, ERINMICHELLE.FAIRFIELD@UPONT.COM, 612.499.4875  DIVING ROOM TOP CAPS / DUPONT, CORIAN, DEEP MINK  PE: DECOR DRAWINGS FOR EXTENT, CONTACT: ERIN FAIRFIELD, ERINMICHELLE.FAIRFIELD@UPONT.COM, 612.499.4875  DIVING ROOM TOP CAPS / DUPONT, CORIAN, DEEP MINK  PE: DECOR DRAWINGS FOR EXTENT, CONTACT: ERIN FAIRFIELD, ERINMICHELLE.FAIRFIELD@UPONT.COM, 612.499.4875  DIVING ROOM TOP CAPS / DUPONT, CORIAN, DEEP MINK  PE: DECOR DRAWINGS FOR EXTENT, CONTACT: ERIN FAIRFIELD, ERINMICHELLE.FAIRFIELD@UPONT.COM, 612.499.4875  DIVING ROOM TOP CAPS / DUPONT, CORIAN, DEEP MINK  PE: DECOR DRAWINGS FOR EXTENT, CONTACT: ERIN FAIRFIELD, ERINMICHELLE.FAIRFIELD@UPONT.COM, 612.499.4875  DIVING ROOM TOP CAPS / DUPONT, CORIAN, DEEP MINK  PE: DECOR DRAWINGS FOR EXTENT, CONTACT: ERIN FAIRFIELD, ERINMICHELLE.FAIRFIELD@UPONT.COM, 612.499.4875  DIVING ROOM TOP CAPS / DUPONT, CORIAN, DEEP MINK  PE: DECOR DRAWINGS FOR EXTENT, CONTACT: ERIN FAIRFIELD, ERINMICHELLE.FAIRFIELD@UPONT.COM, 612.499.4875  DIVING ROOM TOP CAPS / DUPONT, CORIAN, DEEP MINK  PE: DECOR DRAWINGS FOR EXTENT, CONTACT: ERIN FAIRFIELD WITH CONTACT ERIN FAIRFIELD WITH CONTACT ERIN FAIRFIELD	B2	WALK-IN COOLER/FREEZER BASE	4" ALUMINUM COVED BASE	SUPPLIED BY K.E.S.	1
SECRIPTION   SPEC   COMMENTS	QT1	KITCHEN FLOOR TILE	MAYFLOWER RED 31XA (OPTIONAL) - VERIFY W/ MCDONALD'S ACM, GROUT: KERAPOXY IEG BLACK #10 BY MAPEI, CHARCOAL #47 BY MAPEI (FOR OPTIONAL RED TILE) CHEMICAL RESISTANT, WATER-CLEANABLE, TILE-SETTING EPOXY - 100% SOLIDS, INDUSTRIAL-GRADE,	CONTACT: MCD CUSTOMER SERVICE AT 800.978.7500 OR MCD@EUROWEST.COM / JAN DETER 714.309.9551	
Sa   DINING ROOM TOP CAPS / COUNTERS			MISCELLANEOUS		
COUNTERS COU	TAG	AMANANA AMANAN	SPEC	COMMENTS	
Sb   WINDOW SILL / HEADER / RETURNS   DUPONT, CORIAN, DEEP MINK   RE: DECOR DRAWINGS FOR EXTENT, CONTACT: ERIN FAIRFIELD, ERIN.MICHELLE.FAIRFIELD@DUPONT.COM, 612.499.4875	5a		DUPONT, CORIAN, CAMEO WHITE	RE: DECOR DRAWINGS FOR EXTENT, CONTACT: ERIN FAIRFIELD, ERIN.MICHELLE.FAIRFIELD@DUPONT.COM, 612.499.4875	
PICK-UP POD DUPONT, CORIAN, DEEP TITANIUM  RE: DECOR DRAWINGS FOR EXTENT, GC TO COORDINATE ORDERING OF EIS SUPPLIED ITEMS WITH MCDONALD'S AND ACM  LM1 LAMINATE  LAMINATE  LM2 LAMINATE  WHITE PLASTIC LAMINATE  BY GC @ AMENITY TOWER. (KITCHEN SIDE)  LM3 LAMINATE  BY GC @ FRONT COUNTER BASE BOARD (DINING SIDE)	5b	WINDOW SILL / HEADER / RETURNS	DUPONT, CORIAN, DEEP MINK	RE: DECOR DRAWINGS FOR EXTENT, CONTACT: ERIN FAIRFIELD, ERIN.MICHELLE.FAIRFIELD@DUPONT.COM, 612.499.4875	1
LM1 LAMINATE SMOOTH BLACK PLASTIC LAMINATE  LM2 LAMINATE WHITE PLASTIC LAMINATE MATTE BLACK  LM3 LAMINATE FORMICA COMPACT LAMINATE MATTE BLACK  BY GC @ AMENITY TOWER. (KITCHEN SIDE)  BY GC @ FRONT COUNTER BASE BOARD (DINING SIDE)	9f	CORNER GUARDS	SCHLUTER SYSTEMS LP, 5/16" QUADEC TRIM / TUSCAN PEWTER Q80TSG	RE: DECOR DRAWINGS FOR EXTENT, CONTACT: EARL MAICUS: 800.267.0817 EXT. 3410	1
LM2 LAMINATE WHITE PLASTIC LAMINATE  LM3 LAMINATE FORMICA COMPACT LAMINATE BLACK  BY GC @ AMENITY TOWER. (KITCHEN SIDE)  BY GC @ FRONT COUNTER BASE BOARD (DINING SIDE)	43f	PICK-UP POD	DUPONT, CORIAN, DEEP TITANIUM	RE: DECOR DRAWINGS FOR EXTENT, GC TO COORDINATE ORDERING OF EIS SUPPLIED ITEMS WITH MCDONALD'S AND ACM	1
LM3 LAMINATE FORMICA COMPACT LAMINATE MATTE BLACK  BY GC @ FRONT COUNTER BASE BOARD (DINING SIDE)	LM1	LAMINATE	SMOOTH BLACK PLASTIC LAMINATE	BY GC @ IDMB	
	LM2	LAMINATE	WHITE PLASTIC LAMINATE	BY GC @ AMENITY TOWER. (KITCHEN SIDE)	
SCH EDGE PROTECTION "SCHLUTER SYSTEMS", PROFILE: 1/2" QUADEC TRENDLINE, PRODUCT TYPE: IN/OUT CORNER 90°, COLOR: TUSCAN PEWTER CONTACT: EARL MAICUS: 800.267.0817 EXT. 3410	LM3	LAMINATE	FORMICA COMPACT LAMINATE MATTE BLACK	BY GC @ FRONT COUNTER BASE BOARD (DINING SIDE)	
	SCH	EDGE PROTECTION	"SCHLUTER SYSTEMS", PROFILE: 1/2" QUADEC TRENDLINE, PRODUCT TYPE: IN/OUT CORNER 90°, COLOR: TUSCAN PEWTER	CONTACT: EARL MAICUS: 800.267.0817 EXT. 3410	1



LINGLE DESIGN GROUP ING 158 WEST MAIN STREET LENA, IL 61048 815.369.9155 1860 W. EVANS AVE. ENGLEWOOD, CO 80110 303.974.5873 WWW.LINGLEDESIGN.COM

© ALL DRAWINGS AND WRITTEN MATERIAL CONTAINED HEREIN ARE THE PROPERTY OF THE LINGLE DESIGN GROUP, INC. THEY MAY NOT BE REVISED, COPIED, REUSED, OR DISCLOSED IN ANY MANNER WITHOUT WRITTEN AUTHORIZATION FROM THE ARCHITECT.



NATIONAL #:

STATE ID: 131246 PROJECT #: 23-287 10/13/23 DRAWN BY:

#### **REVISIONS**

- 10/13/23 RE-DRAW NEW PROTOTYPE

  11/15/23 QC COMMENTS & PROTO UPDATES
- 3 01/02/24 QC COMMENTS
- 4 01/30/24 CITY COMMENTS
- 5 02/16/24 ELECTRICAL MARK-UPS
- 6 03/11/24 CITY COMMENTS

# McDonald's USA, LLC

ADDRESS


9521 HAVER WAY **INDIANAPOLIS, IN 46240** 

SHEET TITLE


FINISH SCHEDULES

SHEET NUMBER:


A1.4.1

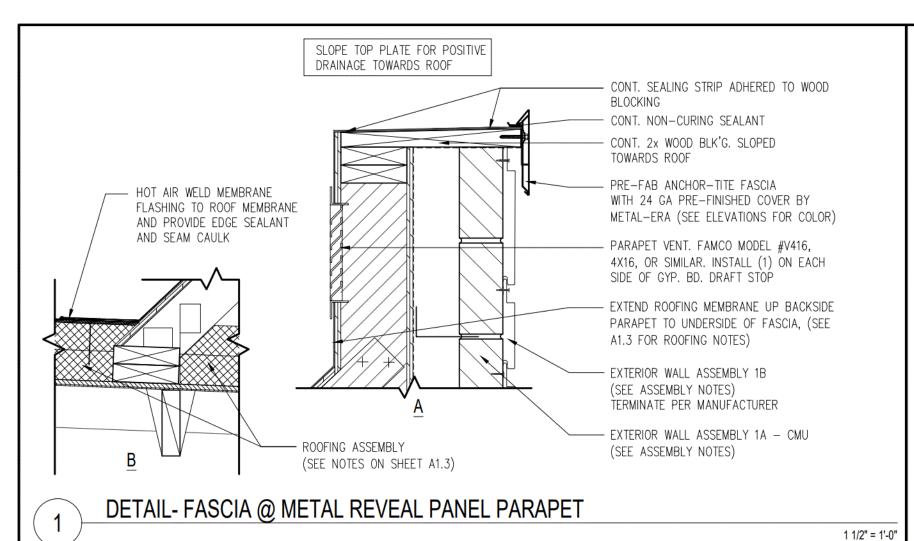

SLOPE TOP PLATE FOR POSITIVE DRAINAGE TOWARDS ROOF CONT. SEALING STRIP ADHERED TO WOOD BLOCKING CONT. NON-CURING SEALANT - LED DOWN LIGHT CONT. 2x WOOD BLK'G. SLOPED TOWARDS ROOF PRE-FAB ANCHOR-TITE FASCIA WITH 24 GA PRE-FINISHED COVER BY METAL-ERA (SEE ELEVATIONS FOR COLOR) METAL FLASHING UP BEHIND FACIA AND OVER BATTEN COLOR TO MATCH SUBSTRATE EXTEND ROOFING MEMBRANE UP BACKSIDE PARAPET TO UNDERSIDE OF FASCIA, (SEE A1.3 FOR ROOFING NOTES) EXTERIOR WALL ASSEMBLY 1D (SEE ASSEMBLY NOTES) TERMINATION PER MANUFACTURER EXTERIOR WALL ASSEMBLY 1A - CMU (SEE ASSEMBLY NOTES) DETAIL- FASCIA @ BATTEN PARAPET 1 1/2" = 1'-0"

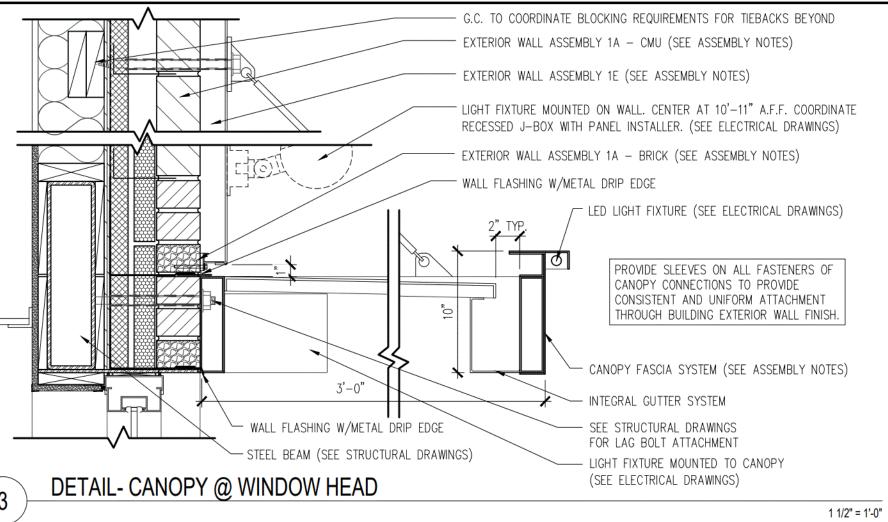

3/4" = 1'-0"

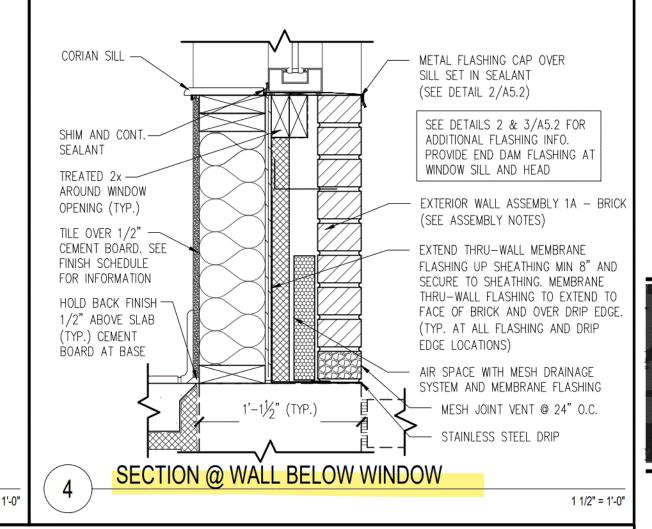



EXTERIOR WINDOW ASSEMBLY (STOREFRONT & ENTRANCE SYSTEM)

GLAZING REQ'S: U VALUE = 0.38 U VALUE "DOOR" = 0.63 SHGC = 0.40 1. DARK BRONZE ANODIZED ALUMINUM FRAME, THERMALLY BROKEN WITH

- HEAD RECEIVER CHANNEL. 2. 1" TEMPERED INSULATED GLAZING
- PROVIDE FLASHING AT HEAD & SILL CONTINUOUS SEALANT.
- 4. PROVIDE METAL CAP @ EXTERIOR BRICK SILL
- 5. 1/2" CORIAN SILL AT INTERIOR

#### CANOPY SYSTEM W/ FASCIA

CANOPY INFORMATION SHOWN IN CONSTRUCTION DOCUMENTS IS FOR DESIGN INTENT ONLY. APPROVED MANUFACTURERS SHALL PROVIDE A COMPLETE AND CODE COMPLIANT FINAL DESIGN. REFER TO ELEVATIONS FOR COLOR OF

- 1. CANOPY STRUCTURE/OUTRIGGERS: CONT. 2" x 8" PAINTED ALUM. TUBE. PROVIDE
- CLOSURE PIECE WHERE TUBE ENDS ARE EXPOSED. 2. FASCIA: CONT. 10"H PAINTED ALUM. w/ LED DOWN-LIGHT FIXTURE OVER CANOPY
- 3. TIEBACKS: PAINTED ALUM. THREADED RODS BY MFR. LOCATIONS AS INDICATED ON ROOF PLAN. FINAL LOCATIONS AND QUANTITY SHALL BE AS INDICATED ON TRELLIS
- INSTALLATION DRAWINGS. 4. WHERE INDICATED ON ROOF PLAN, PROVIDE PAINTED ALUM. PANEL INFILL WITH INTEGRAL GUTTER AND SCUPPER TO MATCH OUTRIGGERS. PANEL TO PROVIDE POSITIVE SLOPE FOR DRAINAGE.
- 5. SYSTEM SHALL ALLOW FOR MOVEMENT AT EXPANSION JOINTS AND FOR MOVEMENT OF EXTERIOR WALL SYSTEM ON WHICH THE CANOPY IS MOUNTED.
- 6. STRUCTURAL ATTACHMENTS & LOAD CALCULATIONS SHALL BE FURNISHED BY CANOPY SYSTEM DESIGNER OF RECORD. SUPPLIER'S DESIGNER OF RECORD SHALL DESIGN PER PREVAILING CODES.
- 7. CANOPY SYSTEM SHALL BE SELECTED FROM ONE OF THE SUPPLIERS LISTED BELOW.
- 8. MANUFACTURER SHALL PROVIDE INSTALLER WITH INSTALLATION INSTRUCTIONS. MANUFACTURER SHALL DESIGN CANOPY IN ACCORDANCE WITH THE WALL SYSTEM AND

BLOCKING AS INDICATED IN THE CONSTRUCTION DOCUMENTS.

9. INSTALLER SHALL NOTIFY CANOPY DESIGNER OF RECORD, McDONALD'S ACM, G.C. AND ARCHITECT OF ANY DEFICIENCIES THAT WOULD NOT ALLOW FOR THE PROPER INSTALLATION OF THE CANOPY. CANOPY SHALL NOT BE INSTALLED UNTIL DEFICIENCIES HAVE BEEN CORRECTED IN ACCORDANCE WITH THE CONSTRUCTION DOCUMENTS AND THE CANOPY MANUFACTURER'S INSTALLATION INSTRUCTIONS.

CANOPY SYSTEM BY: GREENHECK (715) 355-3942 www.greenheck.com

ALL-LITE (817) 509-2300 www.alllite.com

AWNEX (770) 704-7140

www.awnexinc.com WHITE FASCIA & LED LIGHTING BY:

EVERBRITE (888) 857-4078 PERSONA (800) 843-9888 www.everbrite.com www.personasigns.com

#### FOUNDATION AND PERIMETER INSULATION

1. SEE STRUCTURAL DRAWINGS FOR FOUNDATION AND SLAB DETAILS

- 2. PROVIDE RIGID UNDER SLAB INSULATION AS FOLLOWS:
- R-VALUE: R-10 VERTICALLY FROM TOP OF FOOTING TO TOP OF SLAB.

HORIZONTALLY FROM FOUNDATION WALL 2'-0" MIN.

3. 1" - 0.125 ALUMINUM CHANNEL

4. OVER WALL ASSEMBLY 1A

1E. ALPOLIC ACM PANEL

1. 4MM PE CORE ALPOLIC METAL PANEL (4CASM-BJ CLIP SYSTEM). SEE ELEVATIONS

2. OVER WALL ASSEMBLY 1A

- 2. 1 1/2" RIGID INSULATION, R-7.5 VALUE
- 3. PERMEABLE BUILDING WRAP. INSTALL PER LOCAL CODES AND MFR'S SPEC'S.
- 4. 1/2" EXTERIOR GRADE PLYWOOD.
- 5. 2x6 WOOD STUD FRAMING @ 16" O.C. (WITH CONTINUOUS DRAFTSTOP/FIRESTOP BLOCKING AT FINISH CEILING LEVEL).
- 6. UNFACED BATT INSULATION (R VALUE = 13).
- 7. "CERTAINTEED MEMBRAIN" SMART VAPOR RETARDER (SEMI-VAPOR PERMEABLE) BY CERTAINTEED OR EQUAL.
- 8. 1/2" CEMENT BOARD SUBSTRATE FOR ALL TILE LOCATIONS. (TYP.) NON TILE LOCATIONS: 1/2" GYPSUM BOARD TO EXTEND TO DECK ABOVE. UNLESS NOTED OTHERWISE. ALL GYP. BOARD MUST SCORE 10 PER ASTM D3273, REFERENCE CURRENT PROJECT
- 9. SEE A1.0 & ROOM FINISH SCHEDULE FOR ADDITIONAL SUBSTRATE INFORMATION.

#### EXTERIOR WALL ASSEMBLIES FROM EXTERIOR TO INTERIOR

#### 1A. <u>BRICK VENEER</u>

- 1. FULL HEIGHT MODULAR SIZE MASONRY, 4" BRICK VENEER (VISIBLE MASONRY) OR 4" CONCRETE BLOCK VENEER WITH INTEGRAL WATER REPELLENT (NON-VISIBLE), W/NON-CORROSIVE METAL TIES VERTICALLY & HORIZONTALLY PER STRUCTURAL. PROVIDE 10" HIGH MESH DOVETAIL CAVITY DRAINAGE SYSTEM. PROVIDE MESH WEEP VENTS 24" O.C. AT ALL FLASHING LOCATIONS. MORTAR: SM750 SILVERSTONE BY SPEC MIX OR EQ.
- 2. AIR SPACE SIZE VARIES ACCORDING TO OVERALL WALL WIDTH. AT TYP. WALL AIR SPACE IS 2 3/8" WIDE.

1B. METAL REVEAL WALL PANEL SYSTEM

- 1. 7" REVEAL SYSTEM. PREFORMED 1" INTERLOCKING PANELS AND EDGE TRIM. INSTALL PER LOCAL CODES AND MFR'S SPEC'S.
  - a. CUTS MADE TO PANELS IN THE FIELD SHALL BE DONE WITH A "COLD CUT" PROCESS ONLY, I.E. POWER NIBBLER. HEAT OR FRICTION CUT WITH AN ABRASIVE
- OR BLADE SHALL NOT BE USED. b. WHERE HORIZONTAL CUTS ALONG THE LENGTH OF THE PANEL ARE MADE, CARE SHOULD BE TAKEN TO MAKE THE CUTS AT THE TOP OF THE PANEL, WHERE IT IS CONCEALED BY THE FASCIA. VERTICAL CUTS ALONG THE HEIGHT OF THE PANEL SHALL BE CONCEALED UNDER TRIM.

METAL PANEL, FASCIAS, CLOSURES & FASTENERS BY: METAL-ERA (800) 558-2162 www.metalera.com

2. OVER WALL ASSEMBLY 1A

- 1C. <u>VERTICAL BATTEN SYSTEM</u> (WHEN ADJACENT TO ALPOLIC ACM PANEL, ASSEMBLY 1E) 1. ALUMINUM BATTEN W/MOUNTING BACK RAIL. SIZE: 2" WIDE x 2" DEEP. REFER TO EXTERIOR ELEVATIONS FOR COLOR. INSTALL PER LOCAL CODES AND MANUFACTURERS SPECIFICATIONS ON TERMINATION AND INSTALLATION DETAILS. BY SUPPLIER. GC INSTALL 2. 1/2" EXTERIOR HIGH DENSITY OVERLAY (HDO) PLYWOOD, BB, GROUP 1. HDO BOTH FACES. APA TRADEMARKED. SAND WITH COURSE GRIT ALL SURFACES PRIOR TO
- PRIMING. PRIME AND PAINT BOTH SIDES AND ALL EDGES. BY GC, INSTALL BY GC. 3. <u>1.75"</u> – 0.125 ALUMINUM CHANNEL

4. OVER WALL ASSEMBLY 1A VERTICAL BATTEN SYSTEM BY:

B+N INDUSTRIES (650) 393-2315 PIRKKO LUCCHESI

TUBELITE (214) 288-5801 CHASITY DICKSON mcdonalds@tubeliteinc.com

1D. <u>VERTICAL BATTEN SYSTEM</u> - (TYPICAL)


plucchesi@bnind.com

- 1. ALUMINUM BATTEN W/MOUNTING BACK RAIL, SIZE: 2" WIDE x 2" DEEP. REFER TO EXTERIOR ELEVATIONS FOR COLOR. INSTALL PER LOCAL CODES AND MANUFACTURERS SPECIFICATIONS ON TERMINATION AND INSTALLATION DETAILS. BY SUPPLIER. GC INSTALL 2. 1/2" EXTERIOR HIGH DENSITY OVERLAY (HDO) PLYWOOD, BB, GROUP 1. HDO BOTH FACES. APA TRADEMARKED. SAND WITH COURSE GRIT ALL SURFACES PRIOR TO PRIMING. PRIME AND PAINT BOTH SIDES AND ALL EDGES. BY GC, INSTALL BY GC.
- VERTICAL BATTEN SYSTEM BY:


B+N INDUSTRIES (650) 393-2315 PIRKKO LUCCHESI

TUBELITE (214) 288-5801 CHASITY DICKSON mcdonalds@tubeliteinc.com plucchesi@bnind.com


PROVIDE MFG. SHOP DRAWINGS TO ARCHITECT FOR REVIEW. ALPOLIC DAVID KEARNEY 757-286-1005 dave\_kearney@m-chem.com

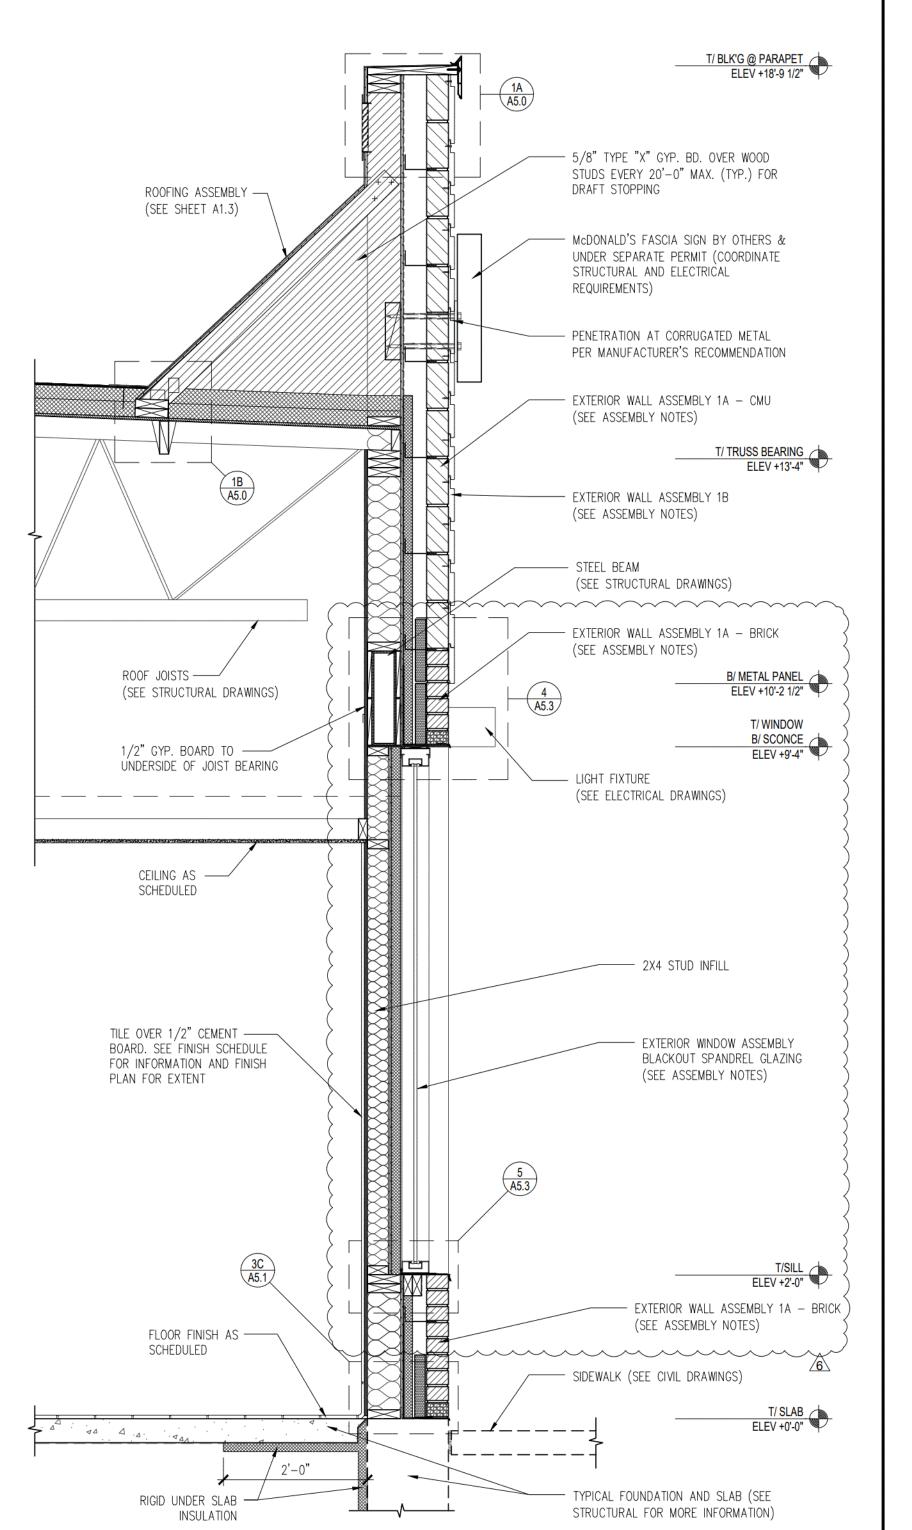

WALL SECTION - RESTROOM (NON-DT SIDE)

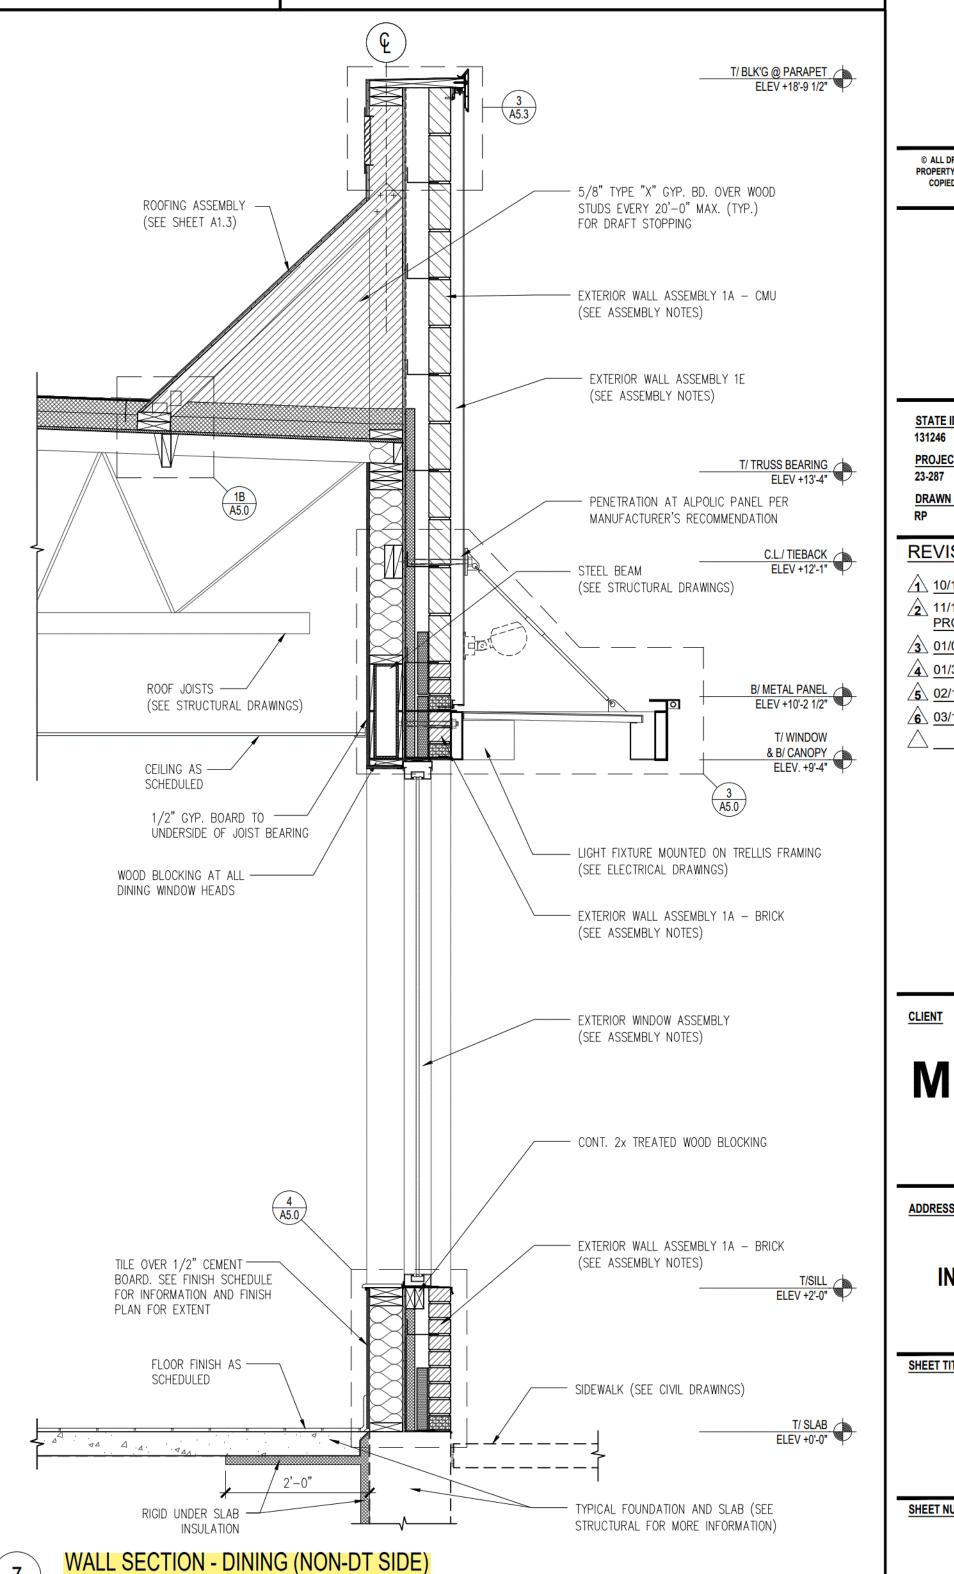

PROPERTY OF THE LINGLE DESIGN GROUP, INC. THEY MAY NOT BE REVISED, COPIED, REUSED, OR DISCLOSED IN ANY MANNER WITHOUT WRITTEN **AUTHORIZATION FROM THE ARCHITECT.** 

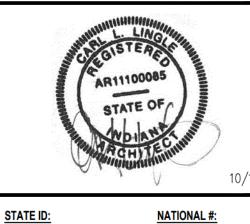

10/13/23

### REVISIONS

10/13/23 - RE-DRAW NEW PROTOTYPE 2 11/15/23 - QC COMMENTS &

3 01/02/24 - QC COMMENTS

PROTO UPDATES

▲ 01/30/24 - CITY COMMENTS

5 02/16/24 - ELECTRICAL MARK-UPS

6 03/11/24 - CITY COMMENTS

# McDonald's USA, LLC

**ADDRESS** 


9521 HAVER WAY **INDIANAPOLIS, IN 46240** 

SHEET TITLE


WALL SECTIONS AND DETAILS


SHEET NUMBER:


3/4" = 1'-0"

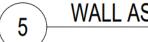



WALL ASSEMBLY NOTES

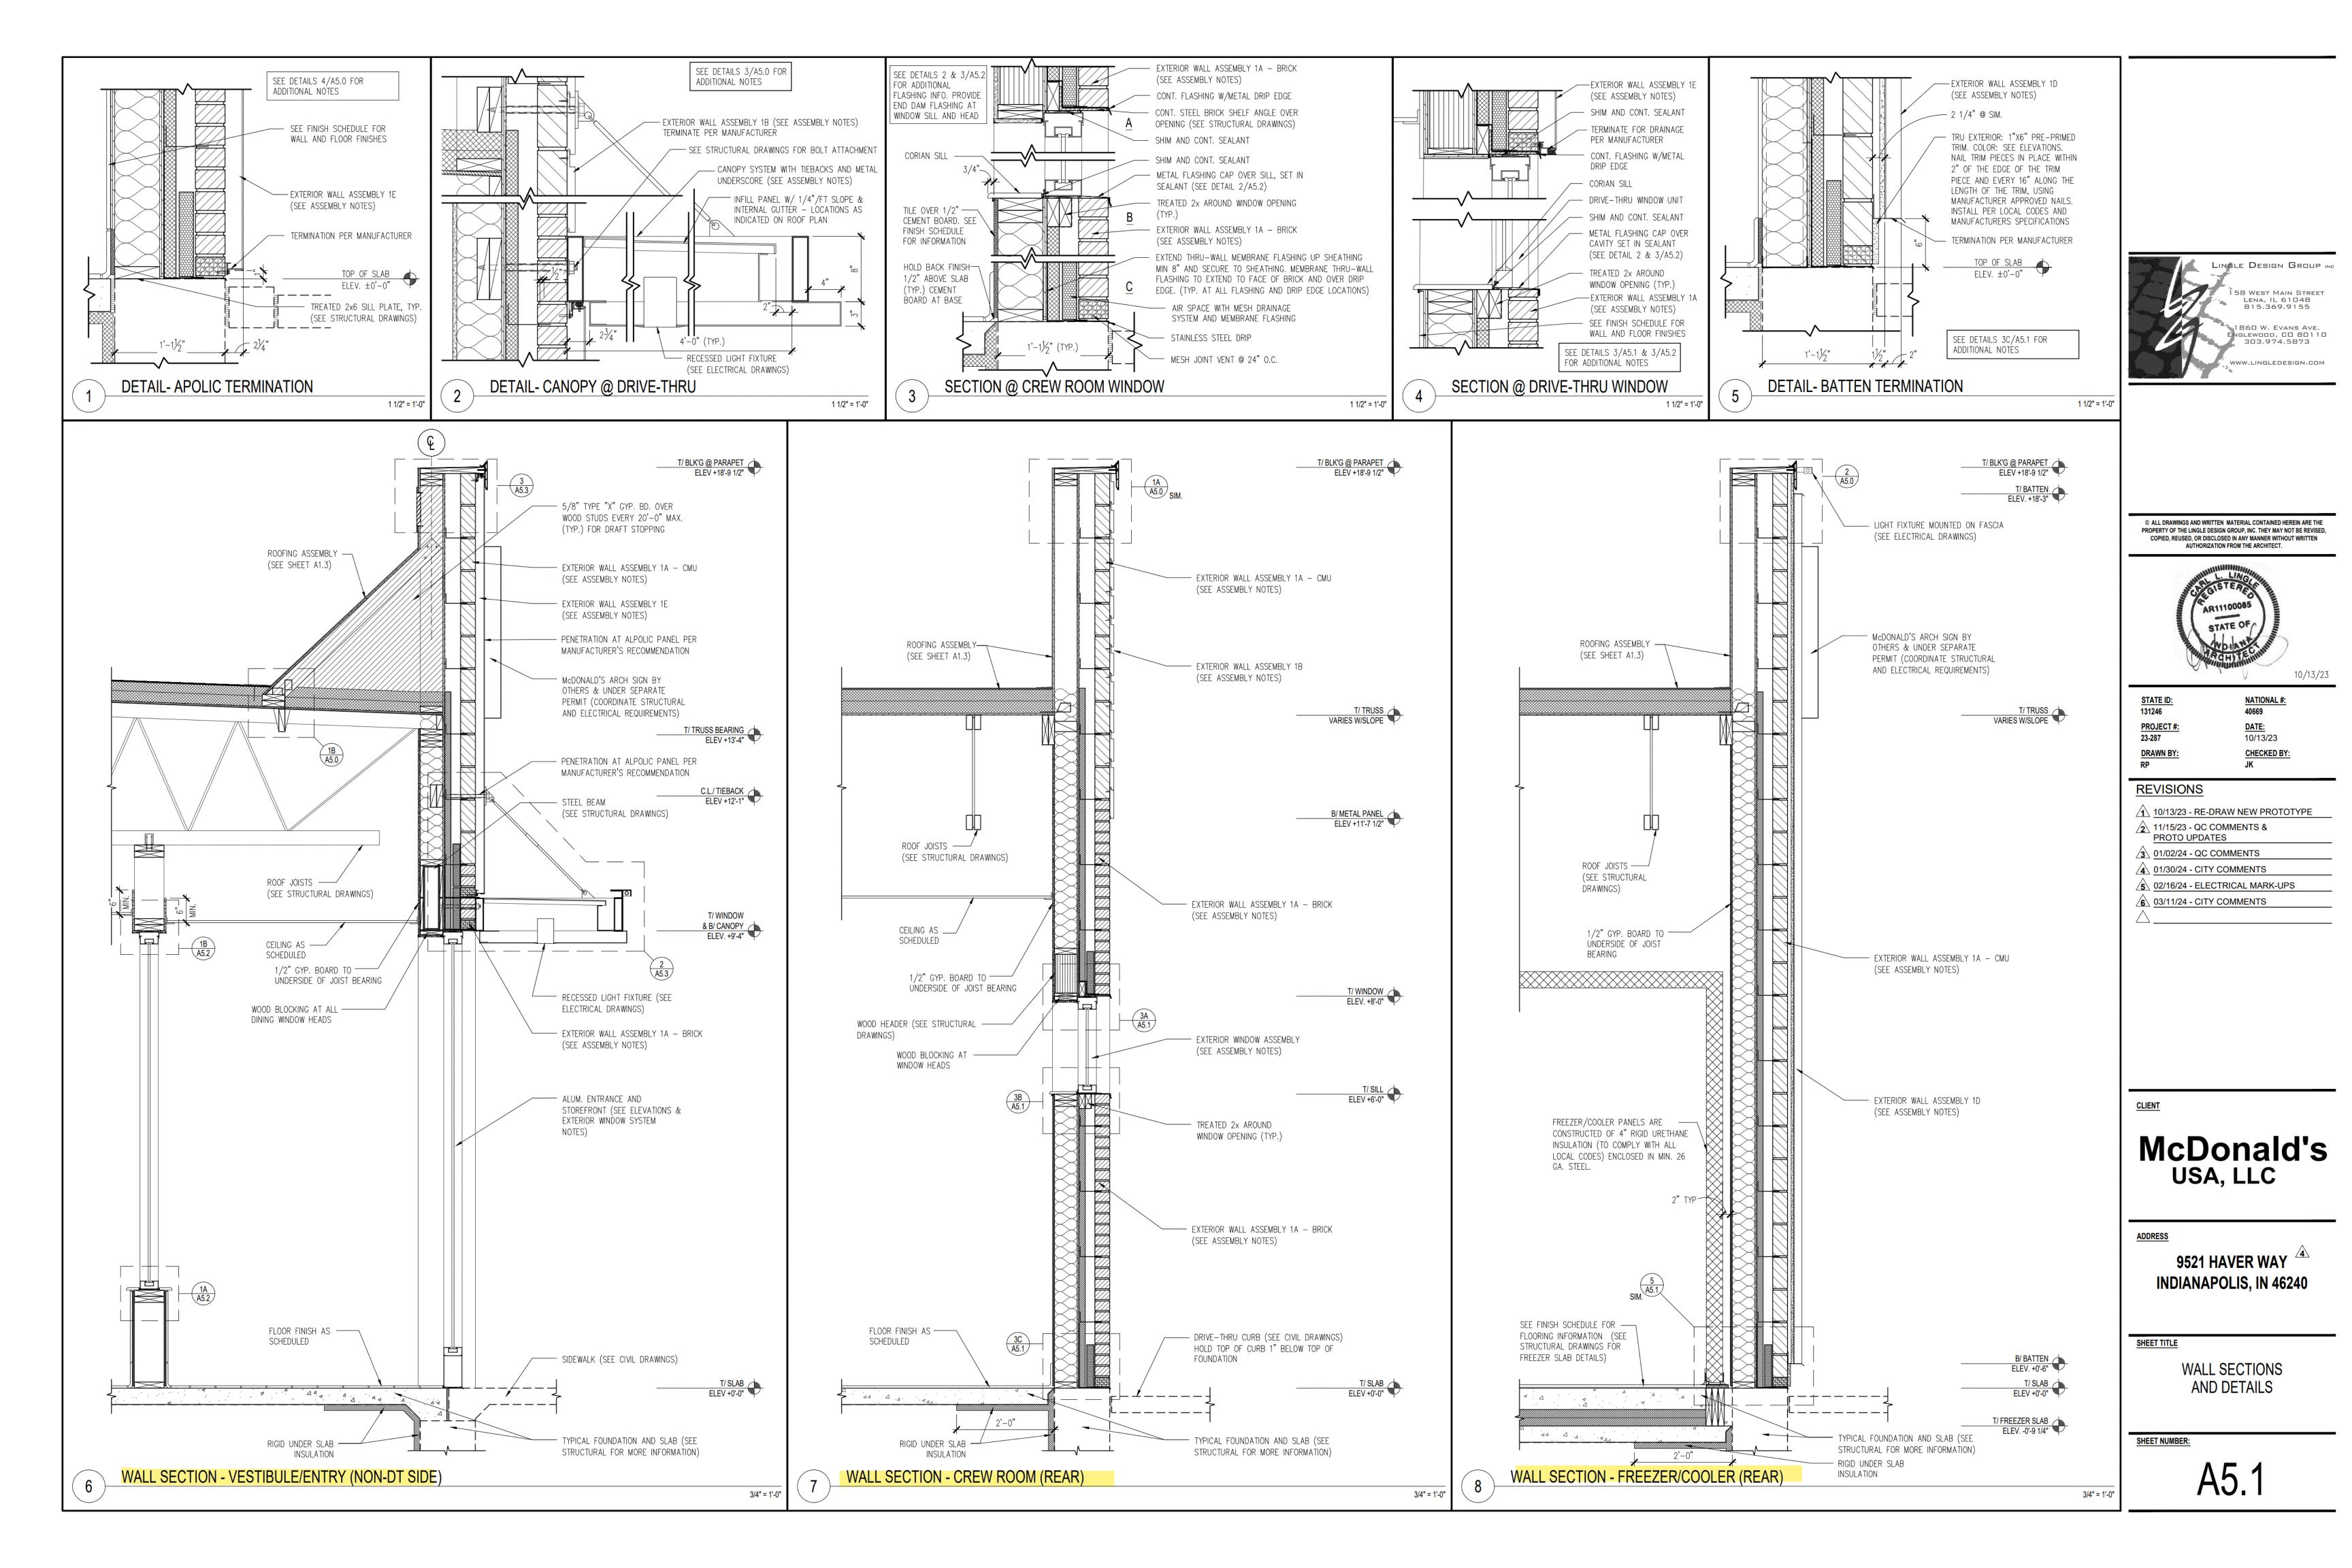


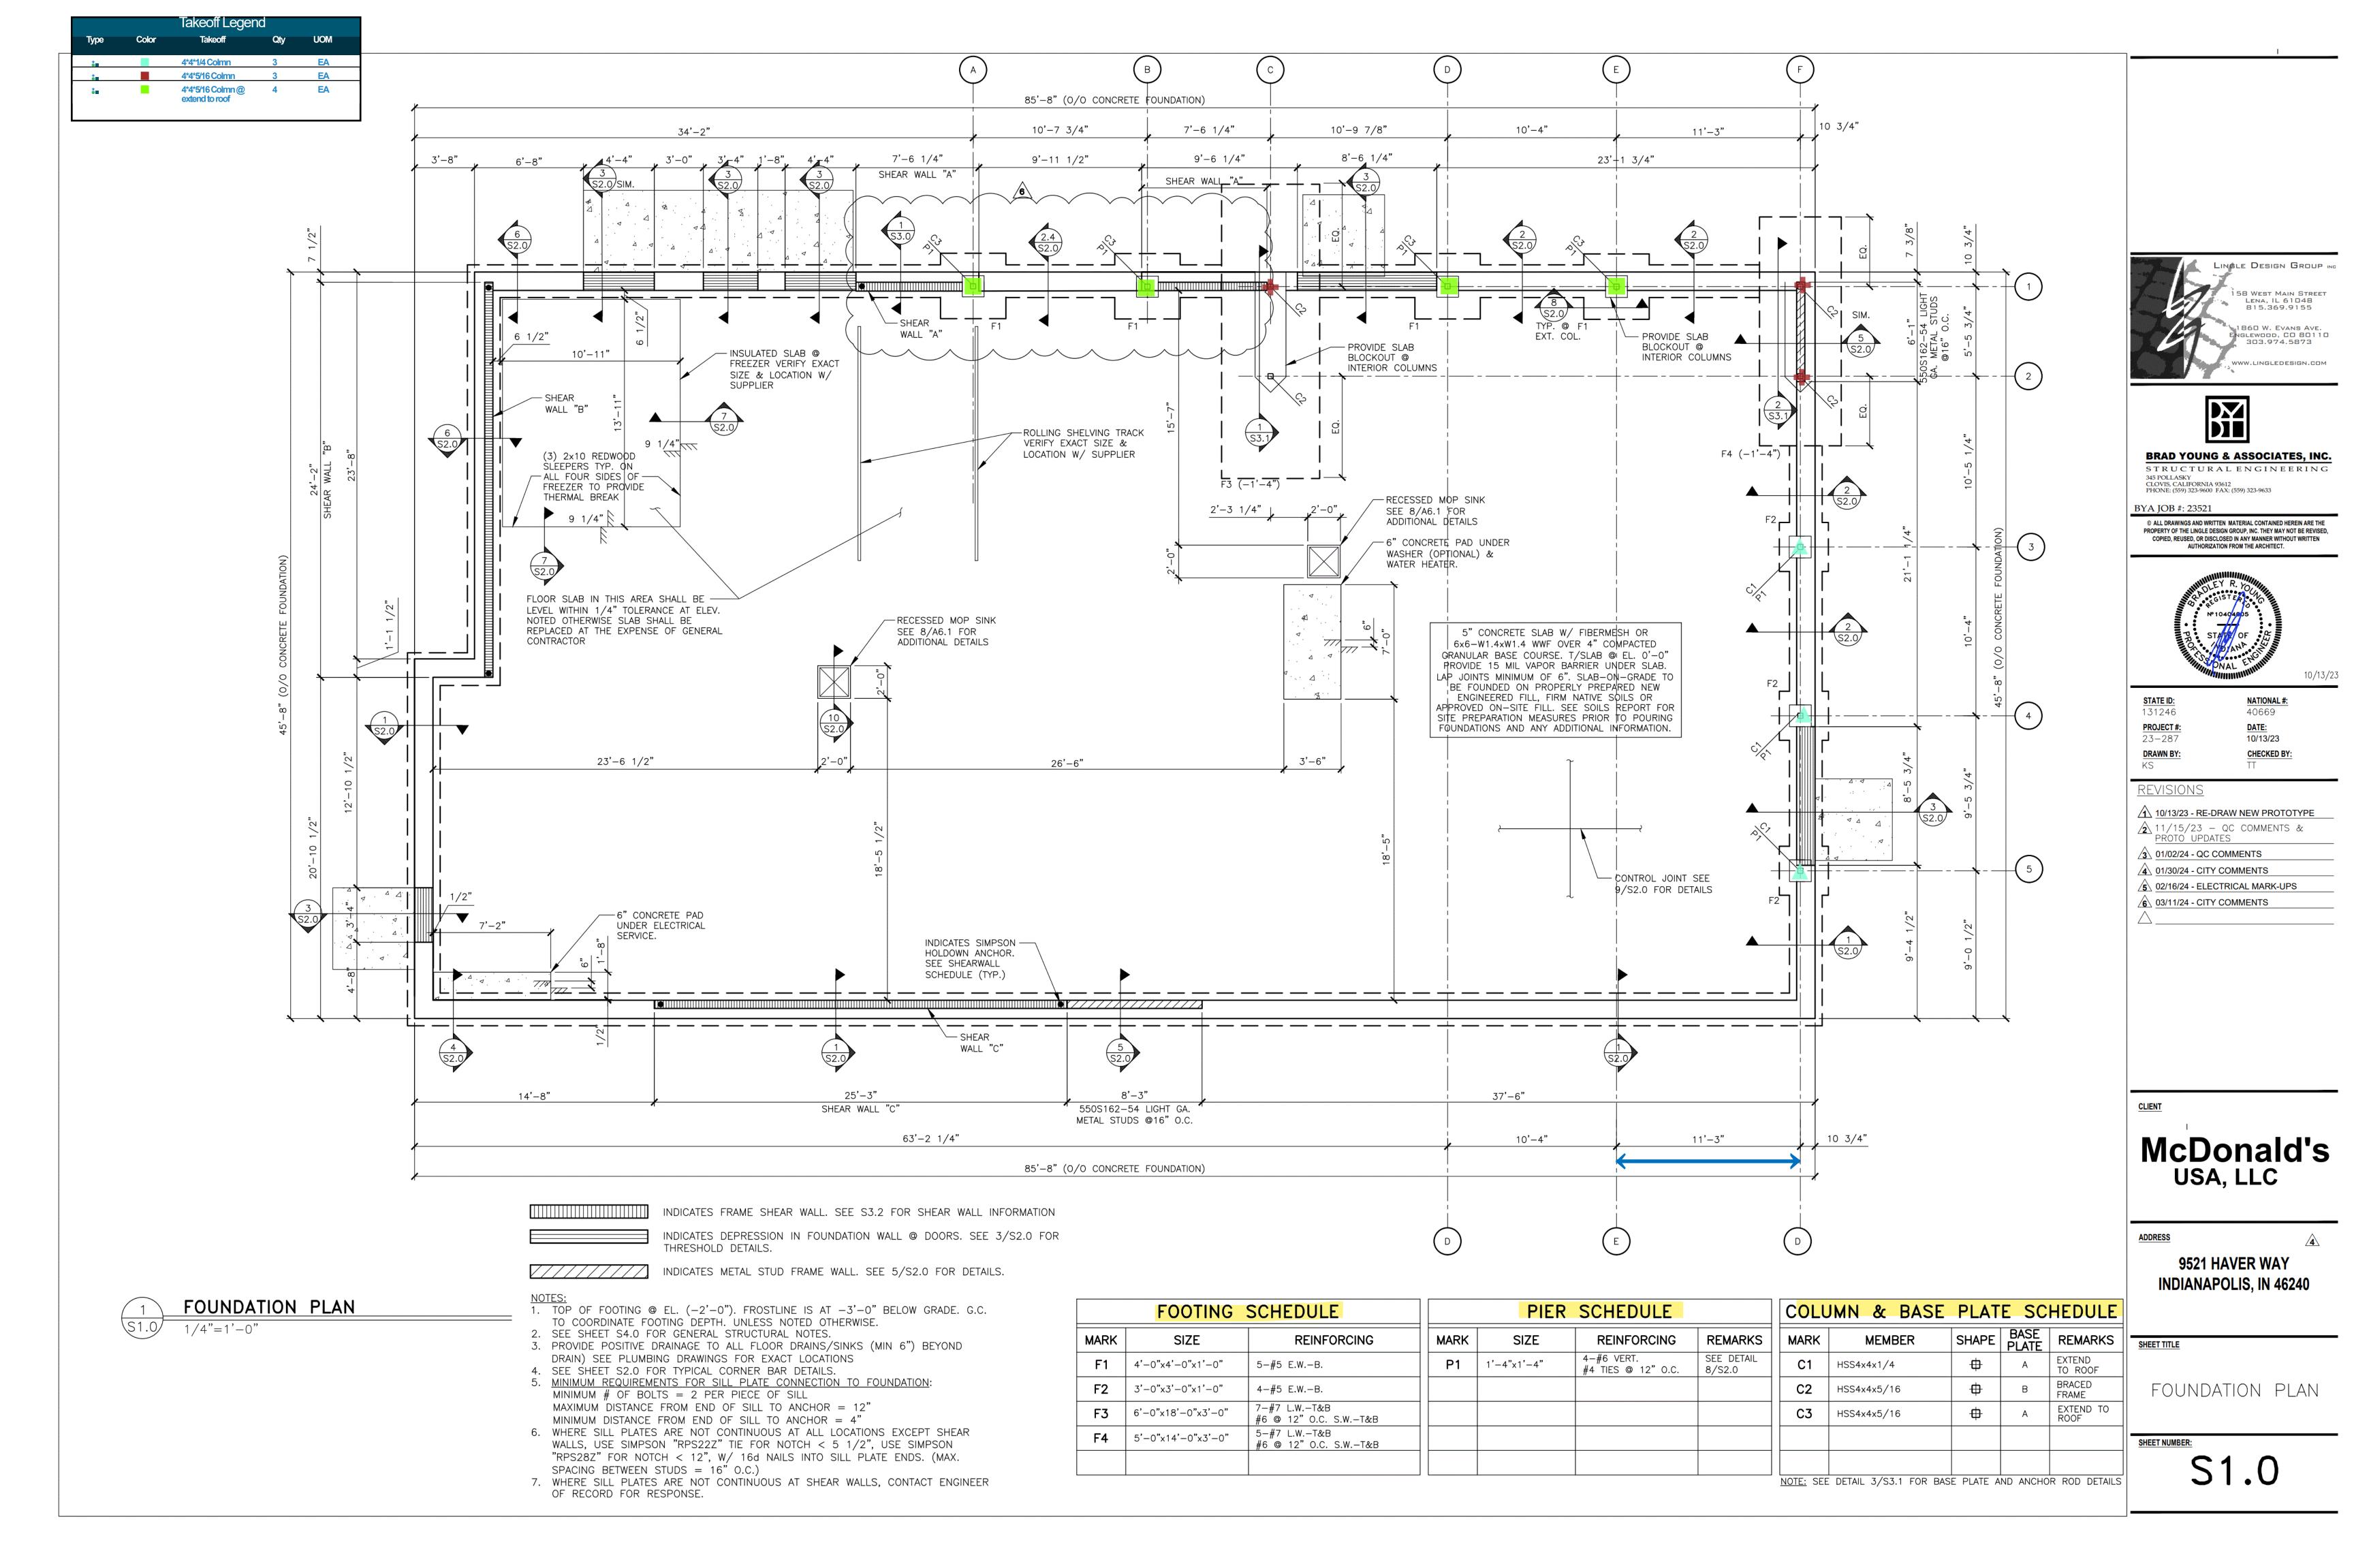


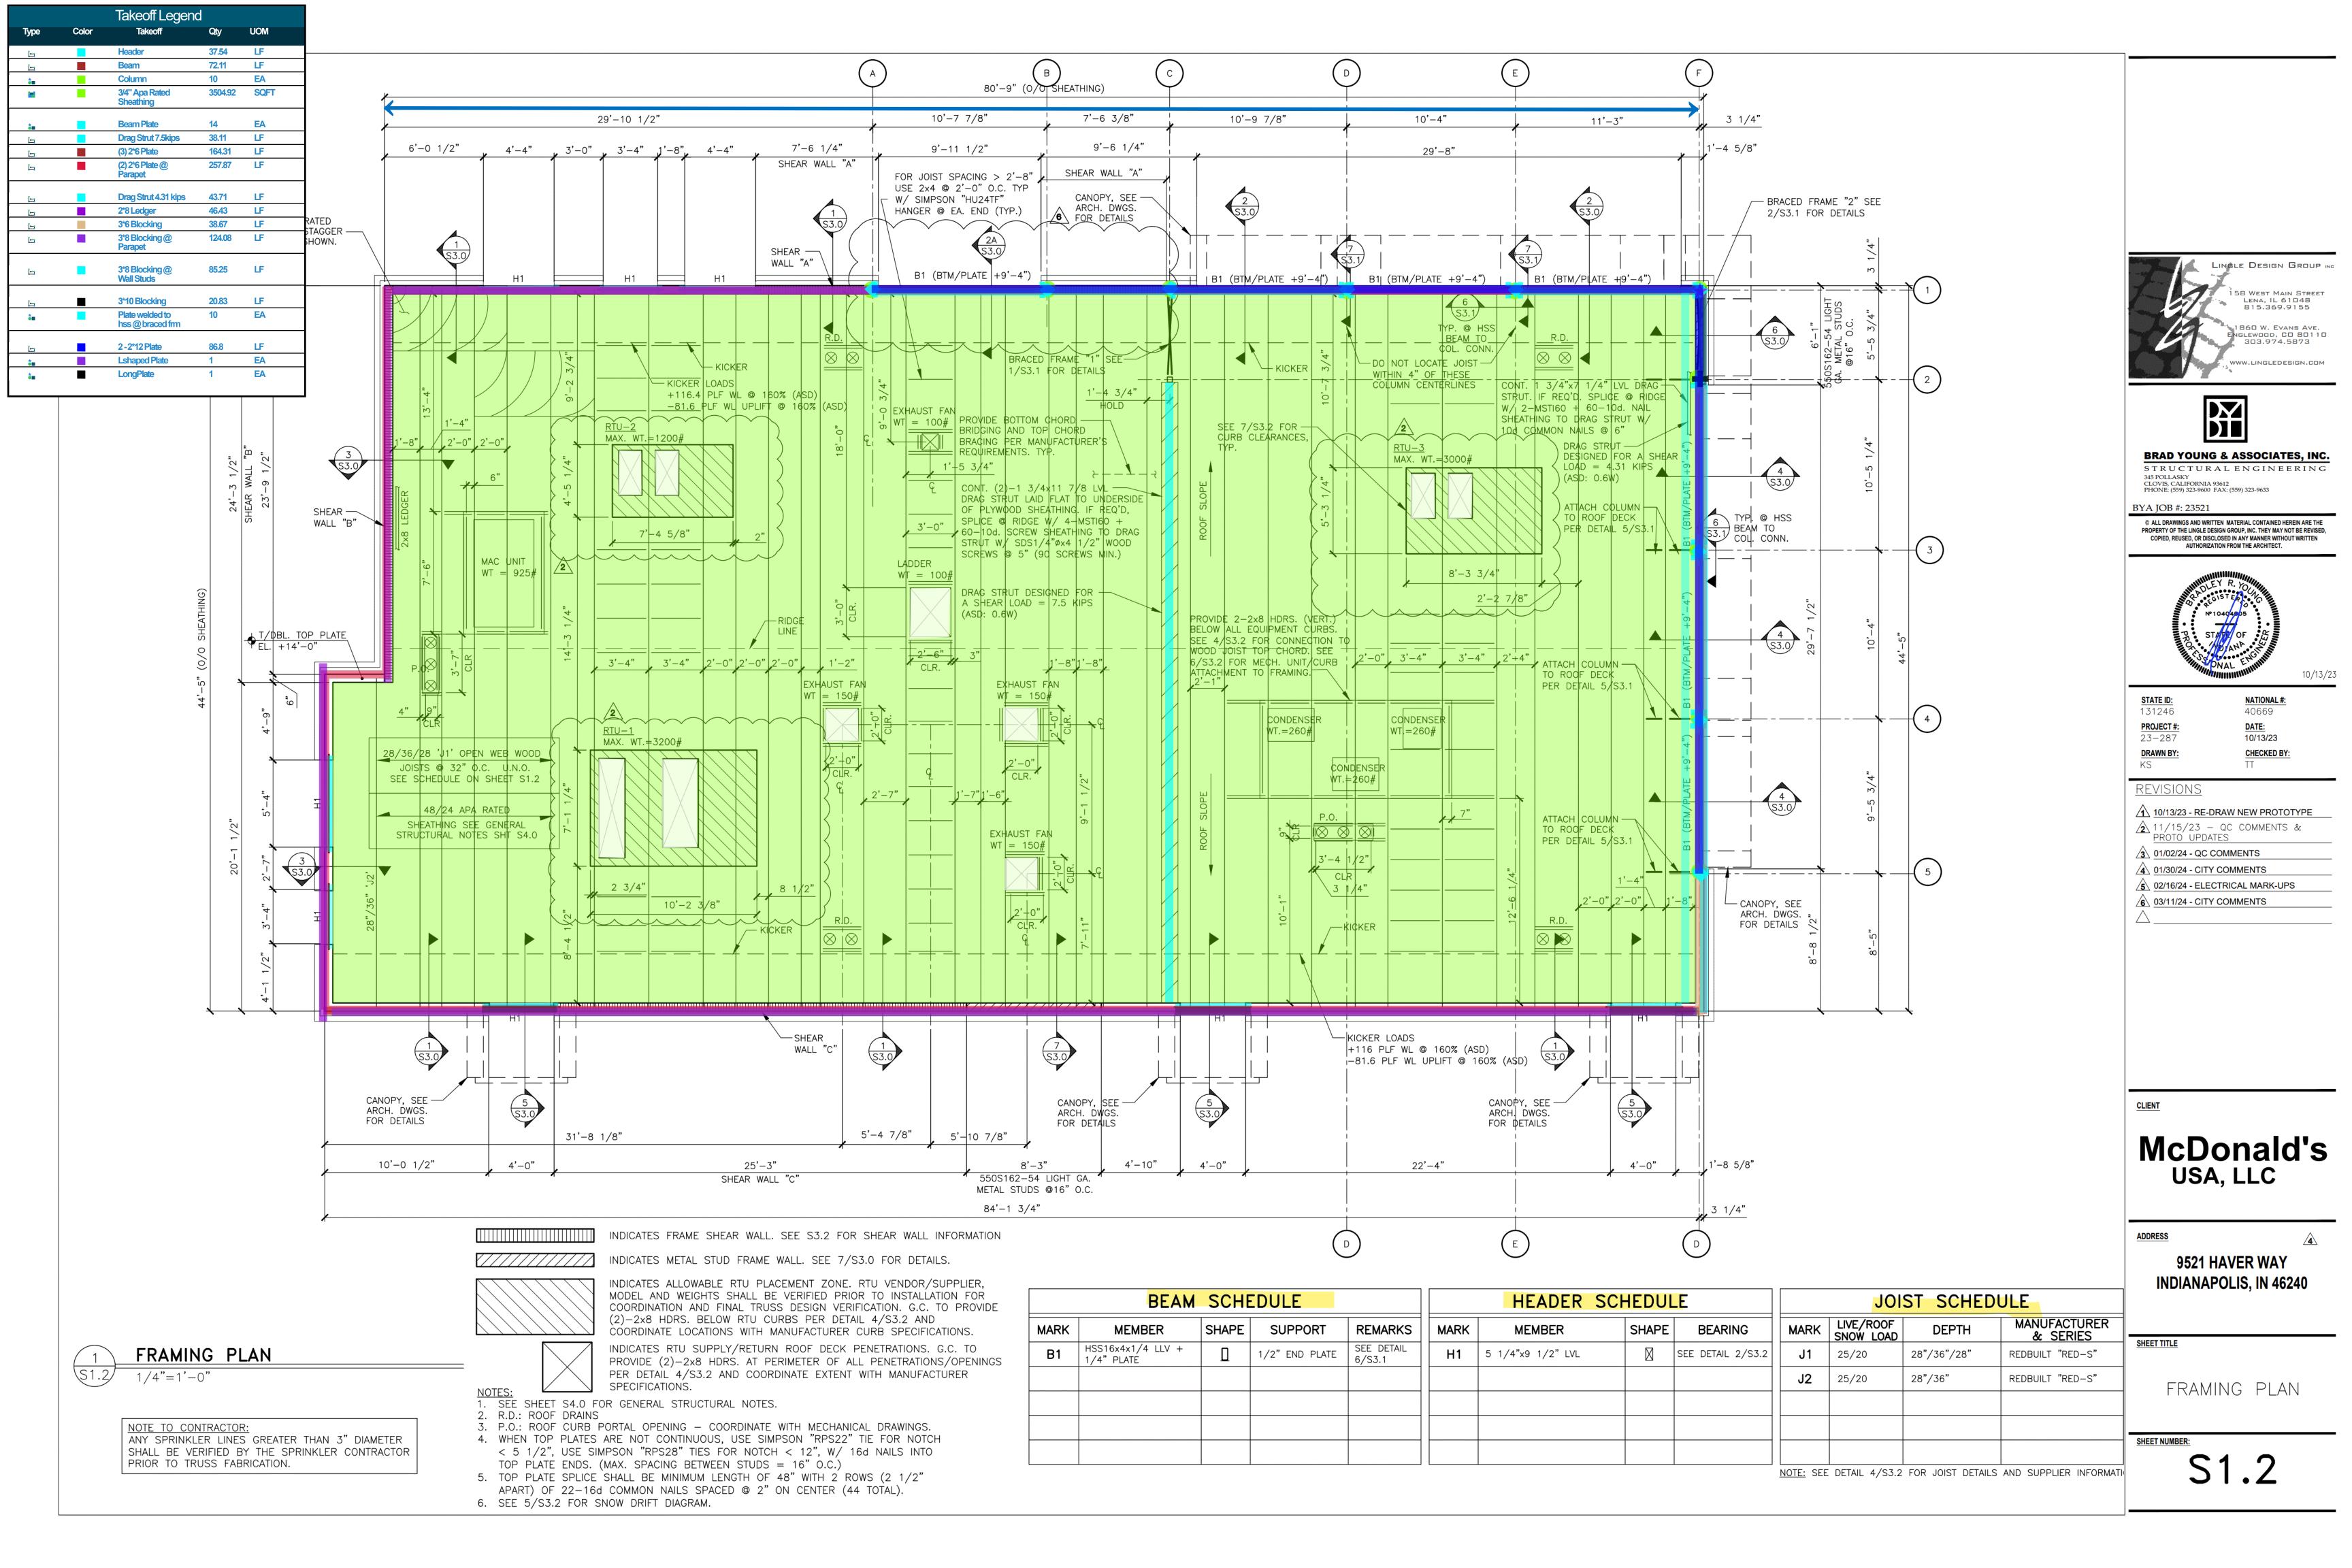

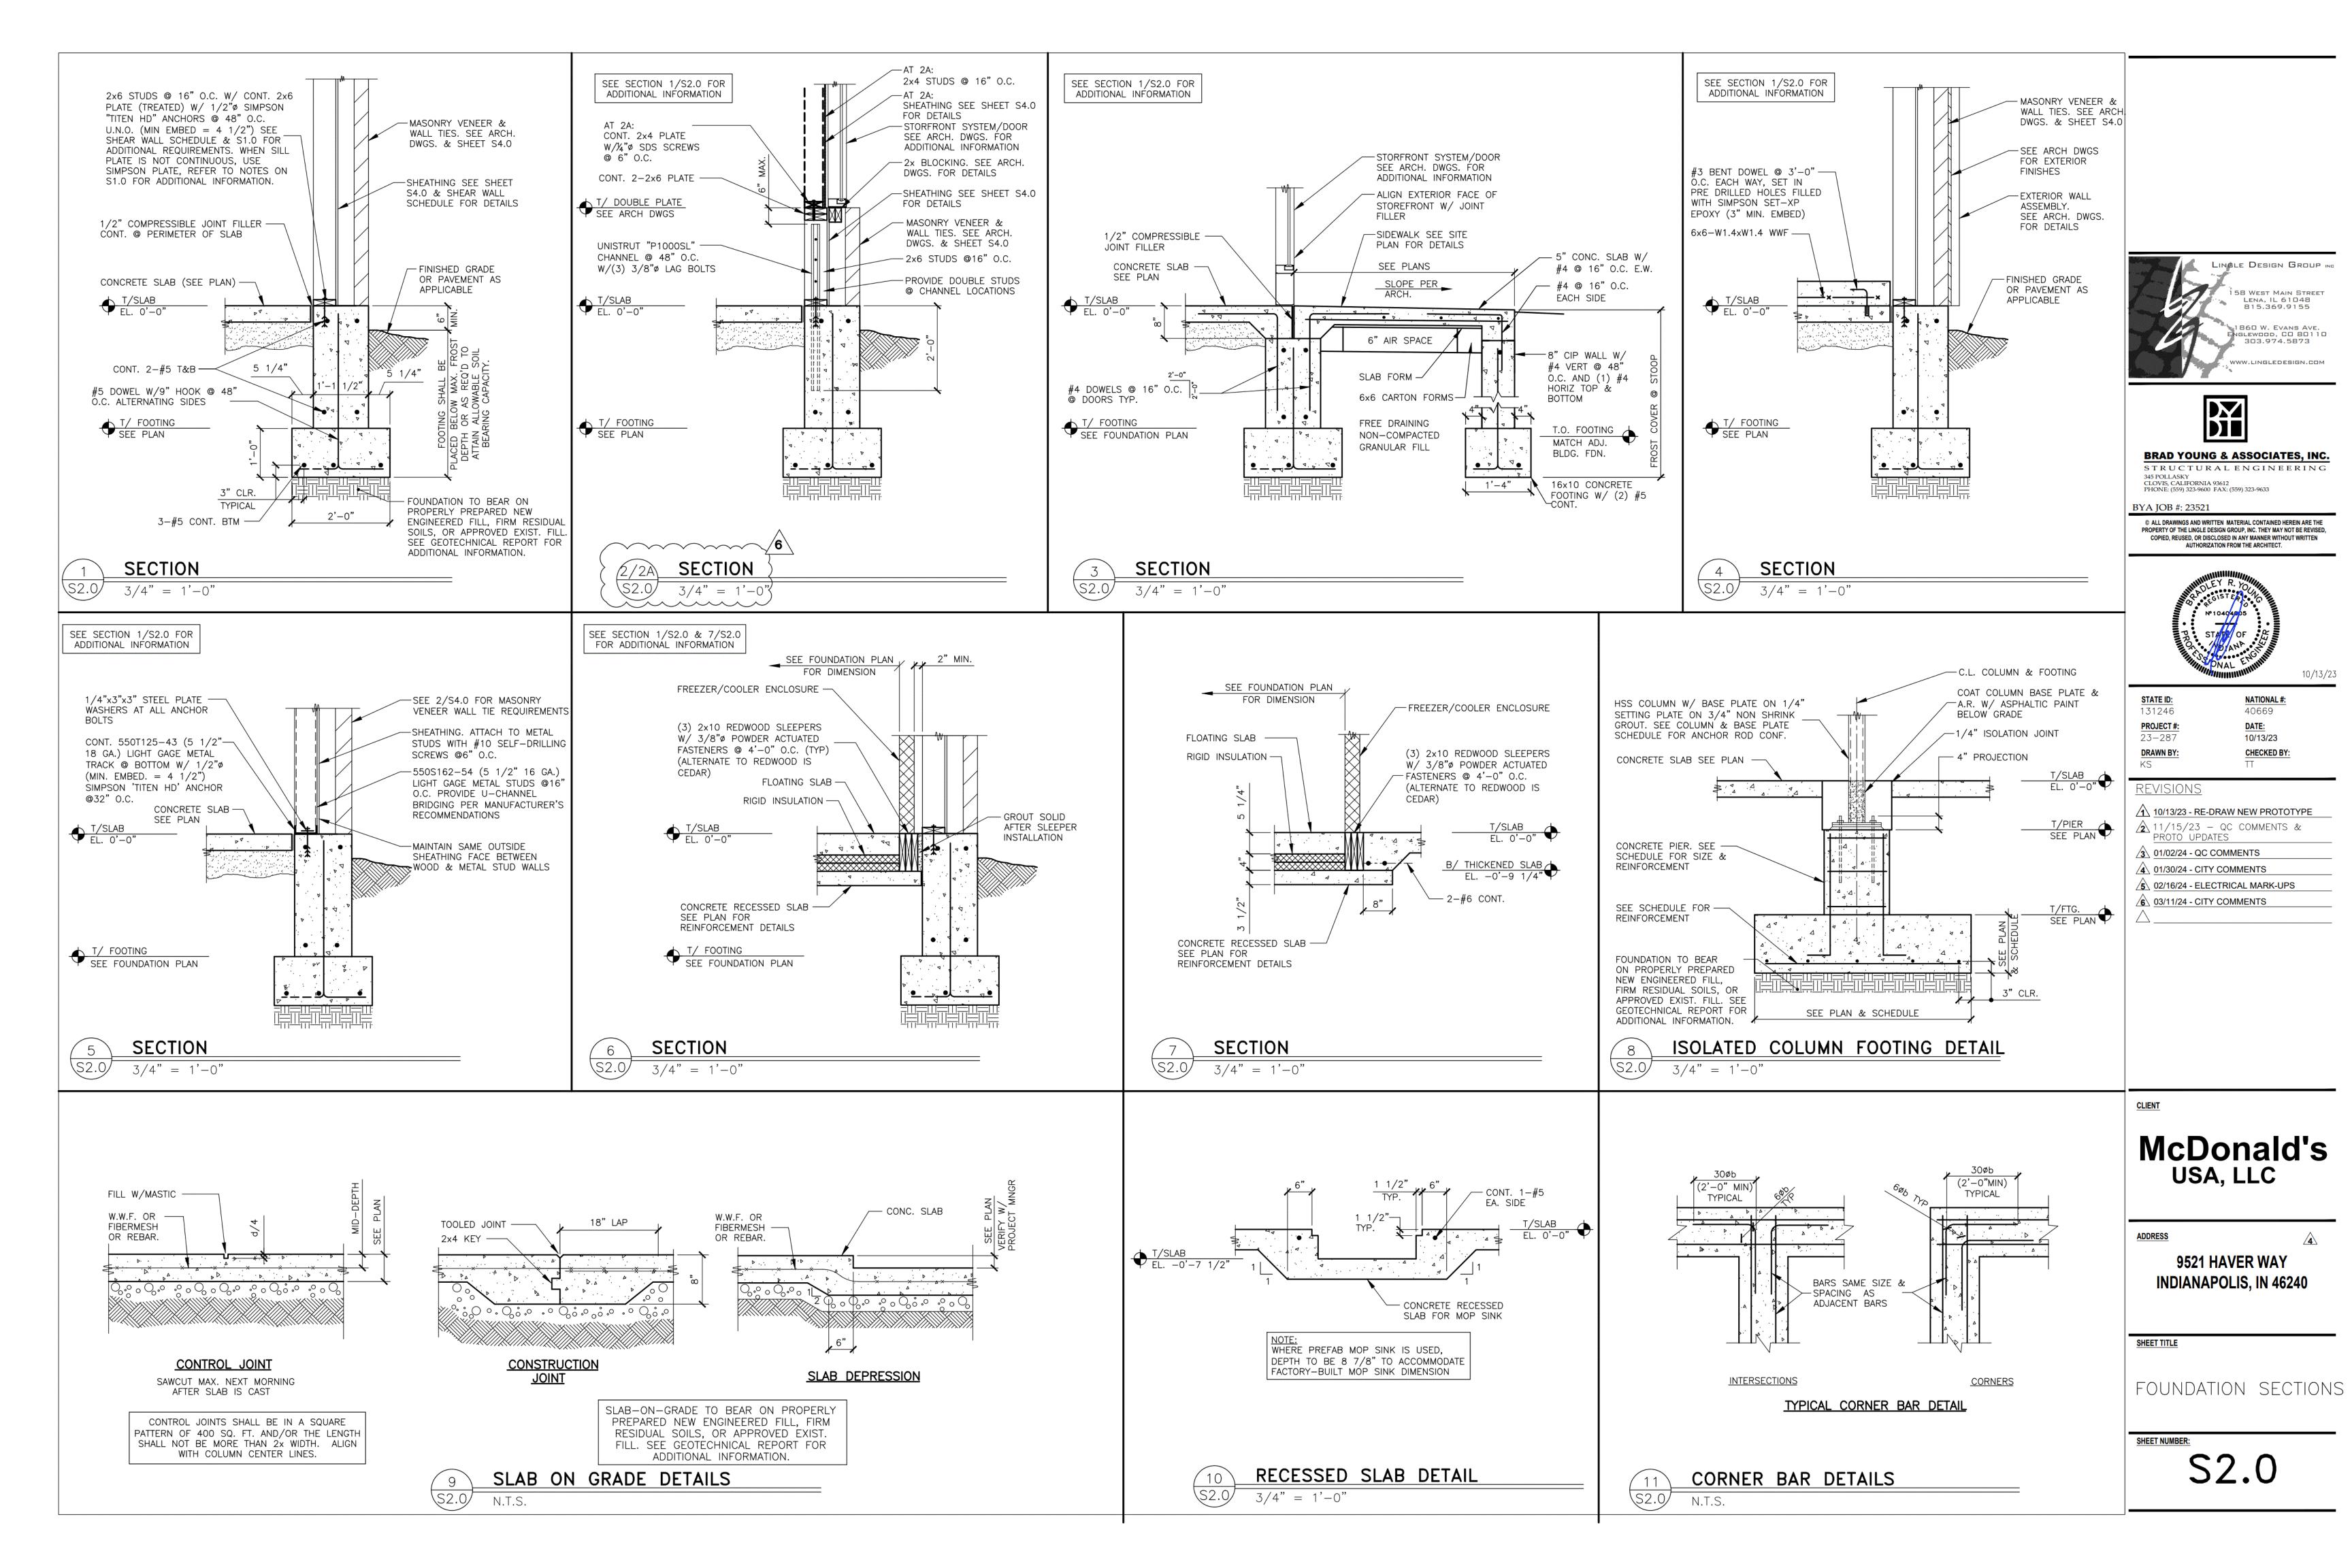

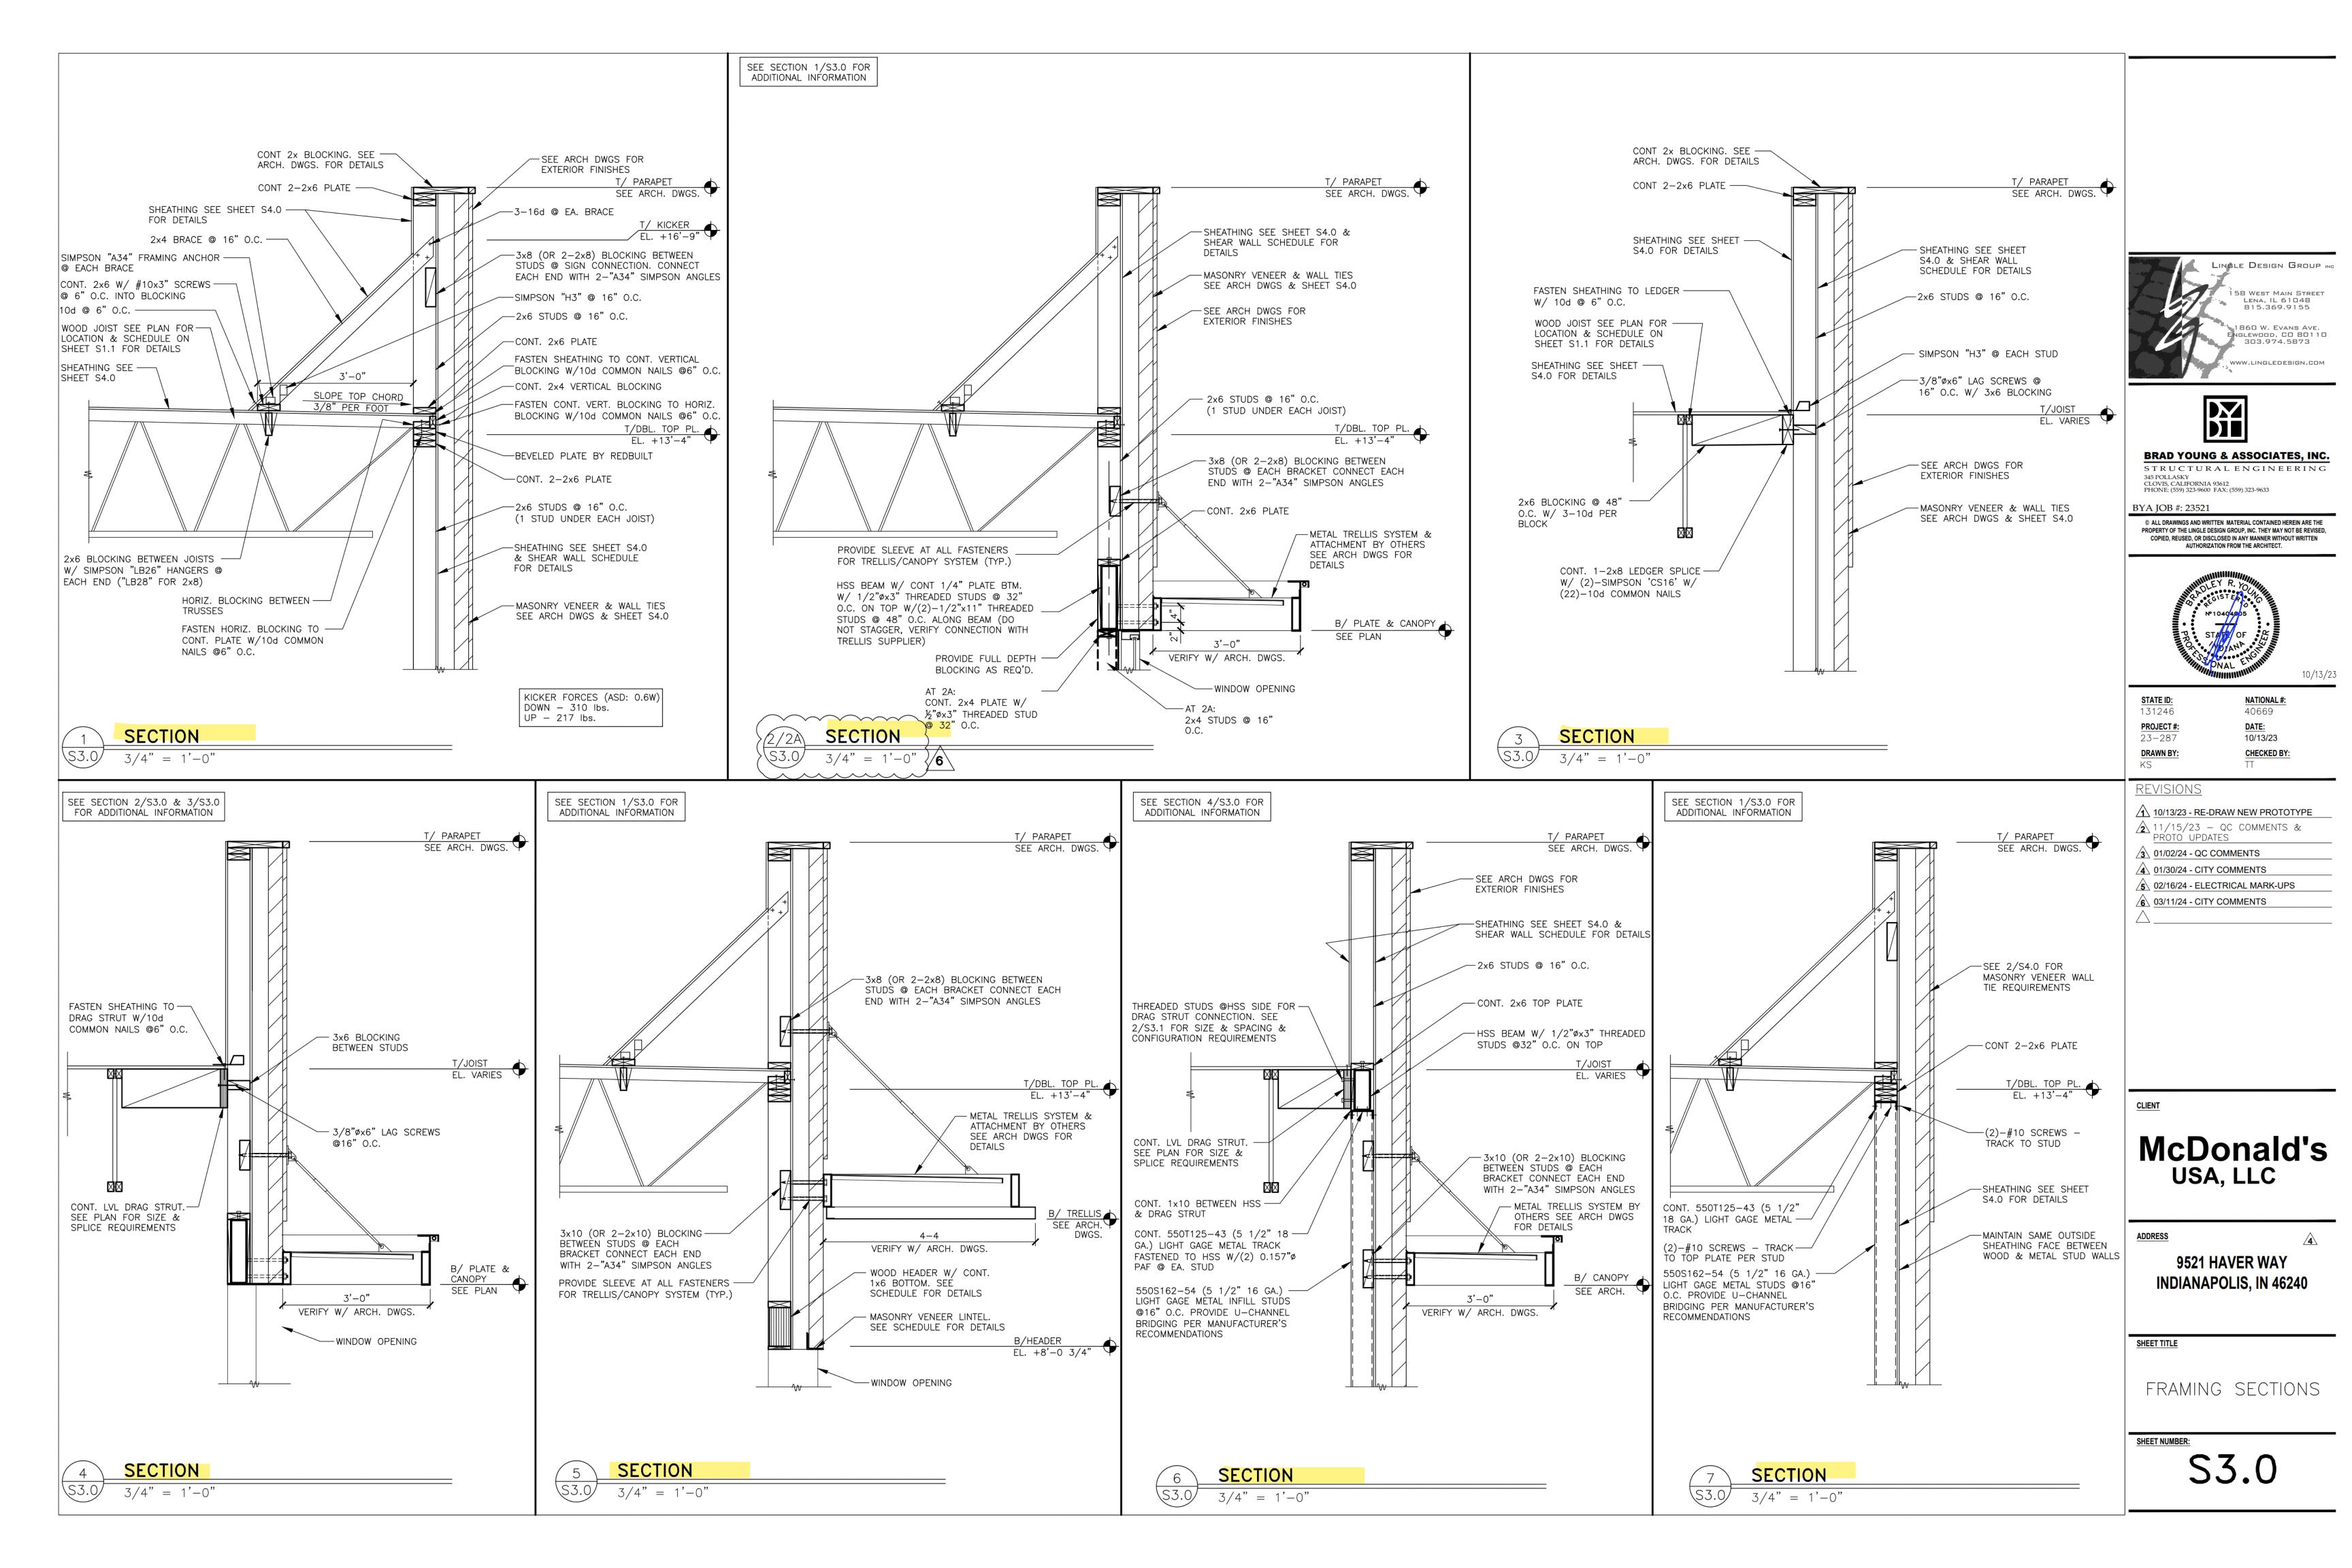

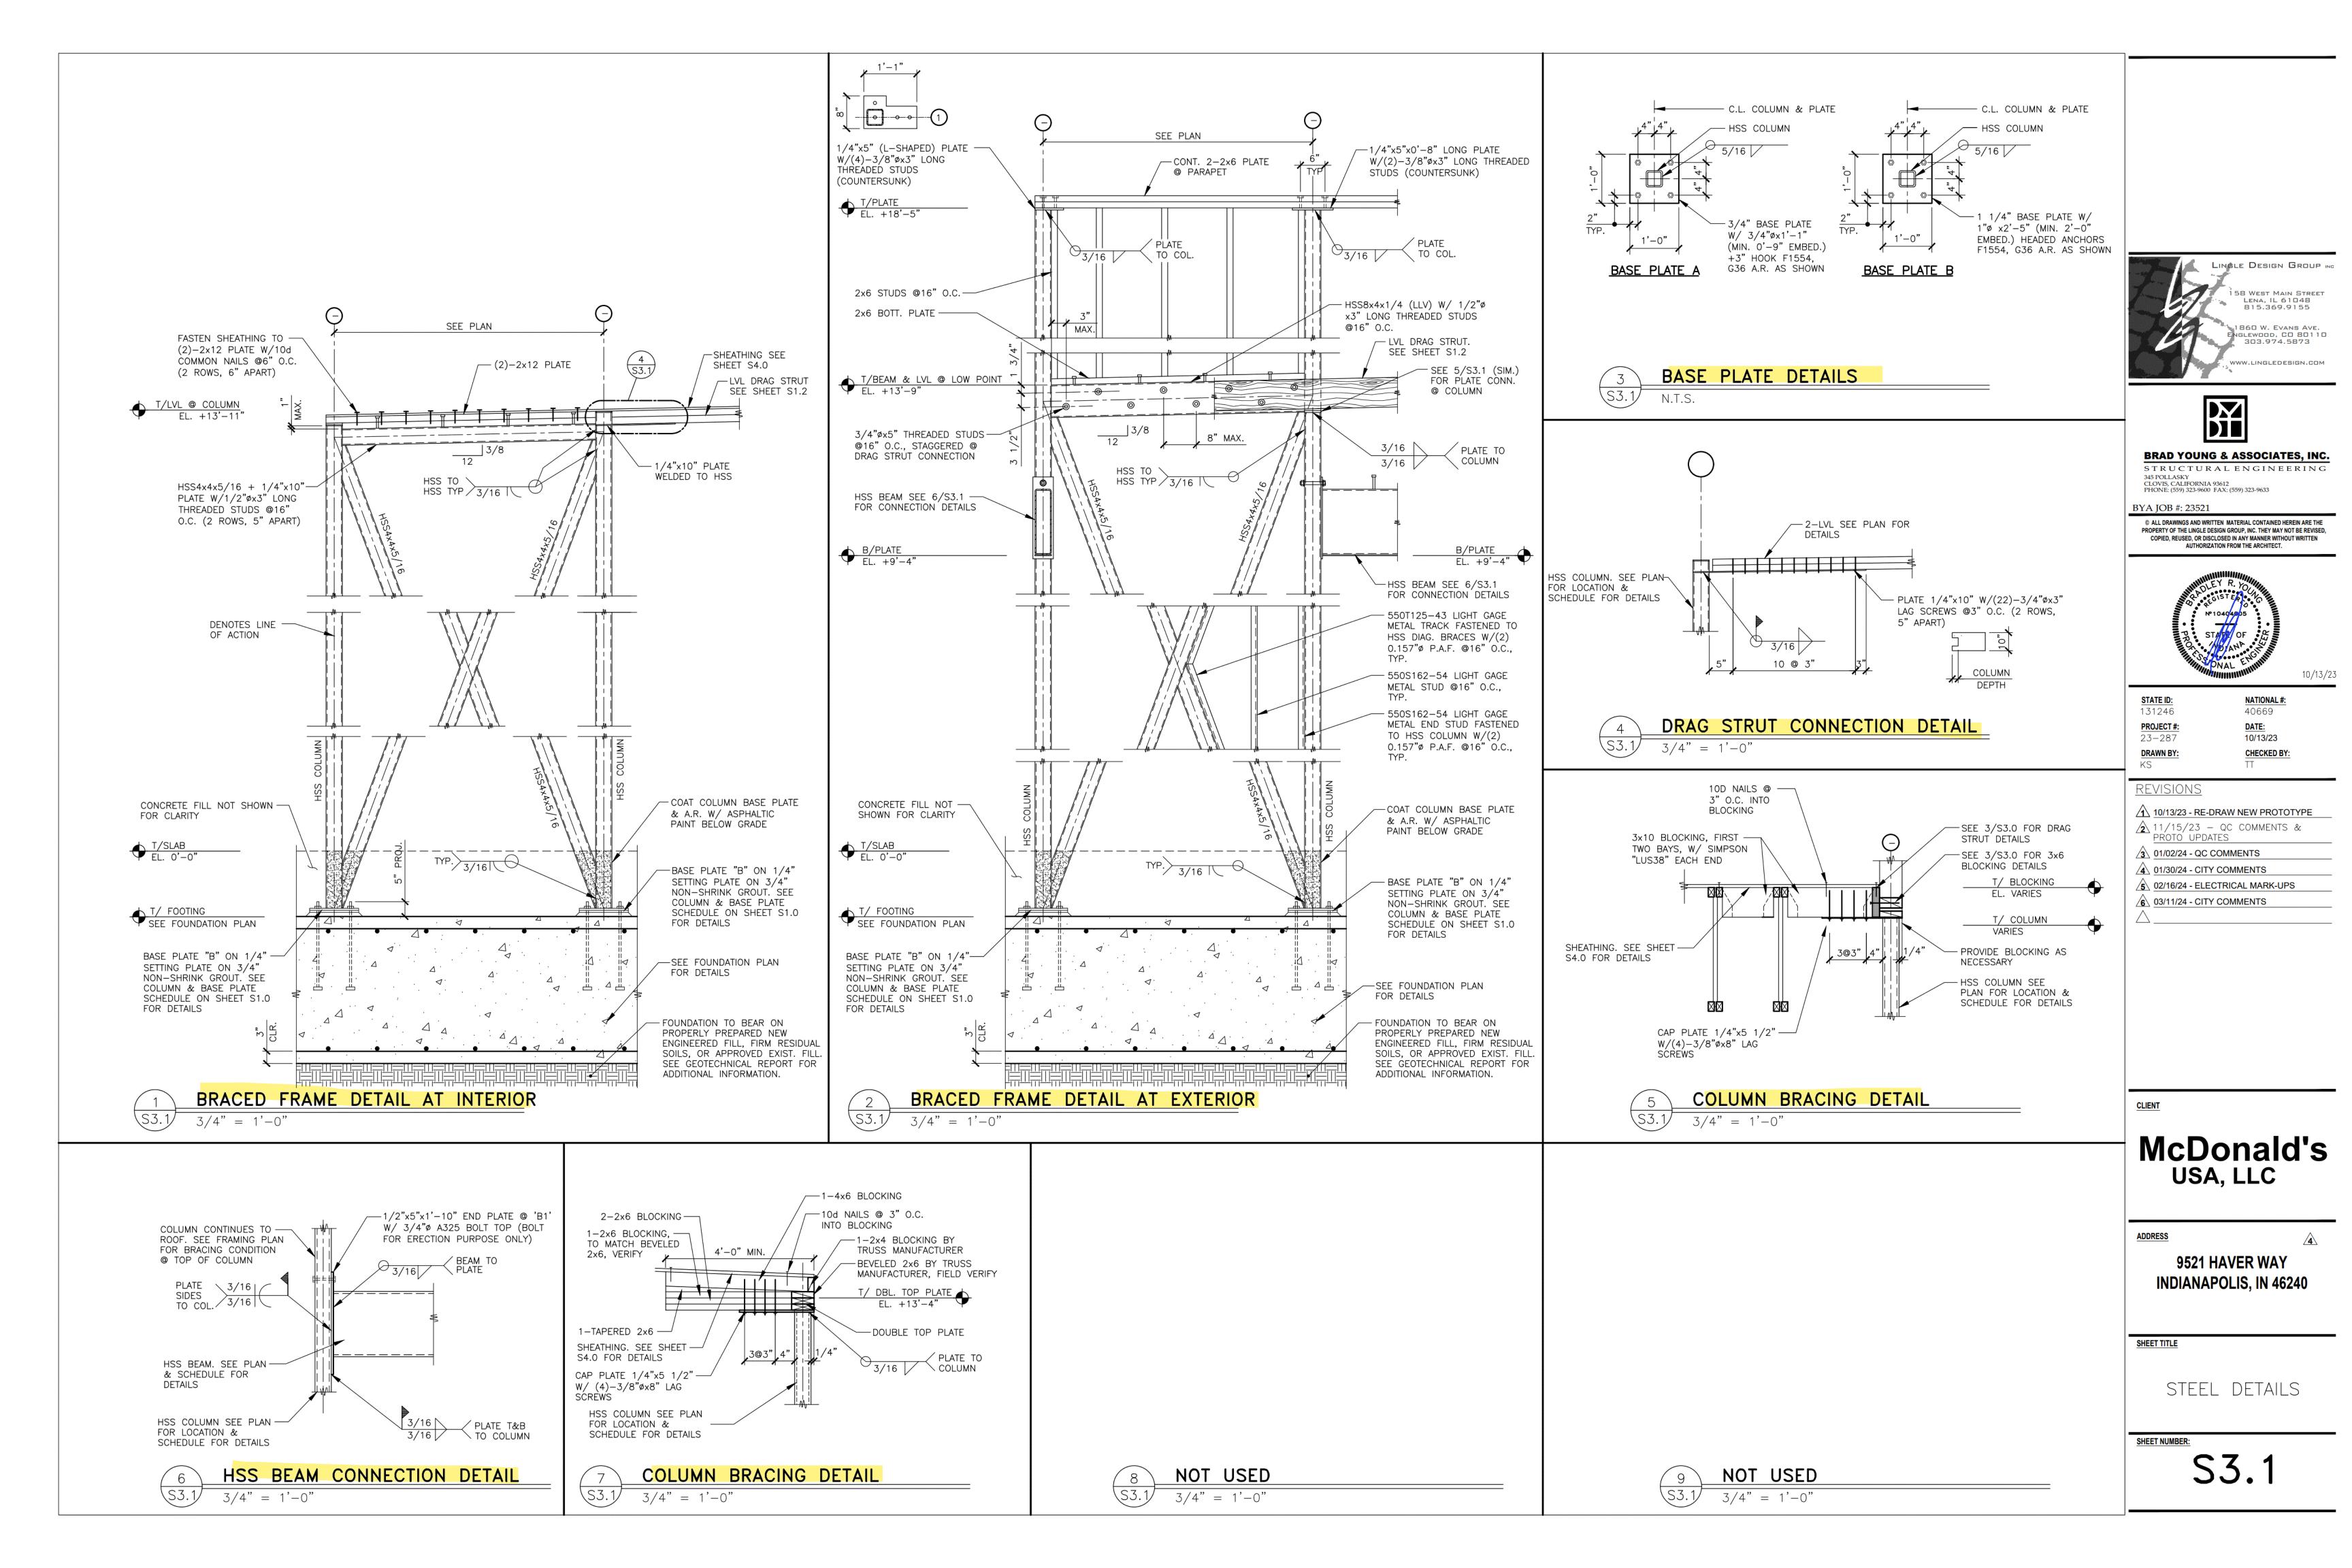

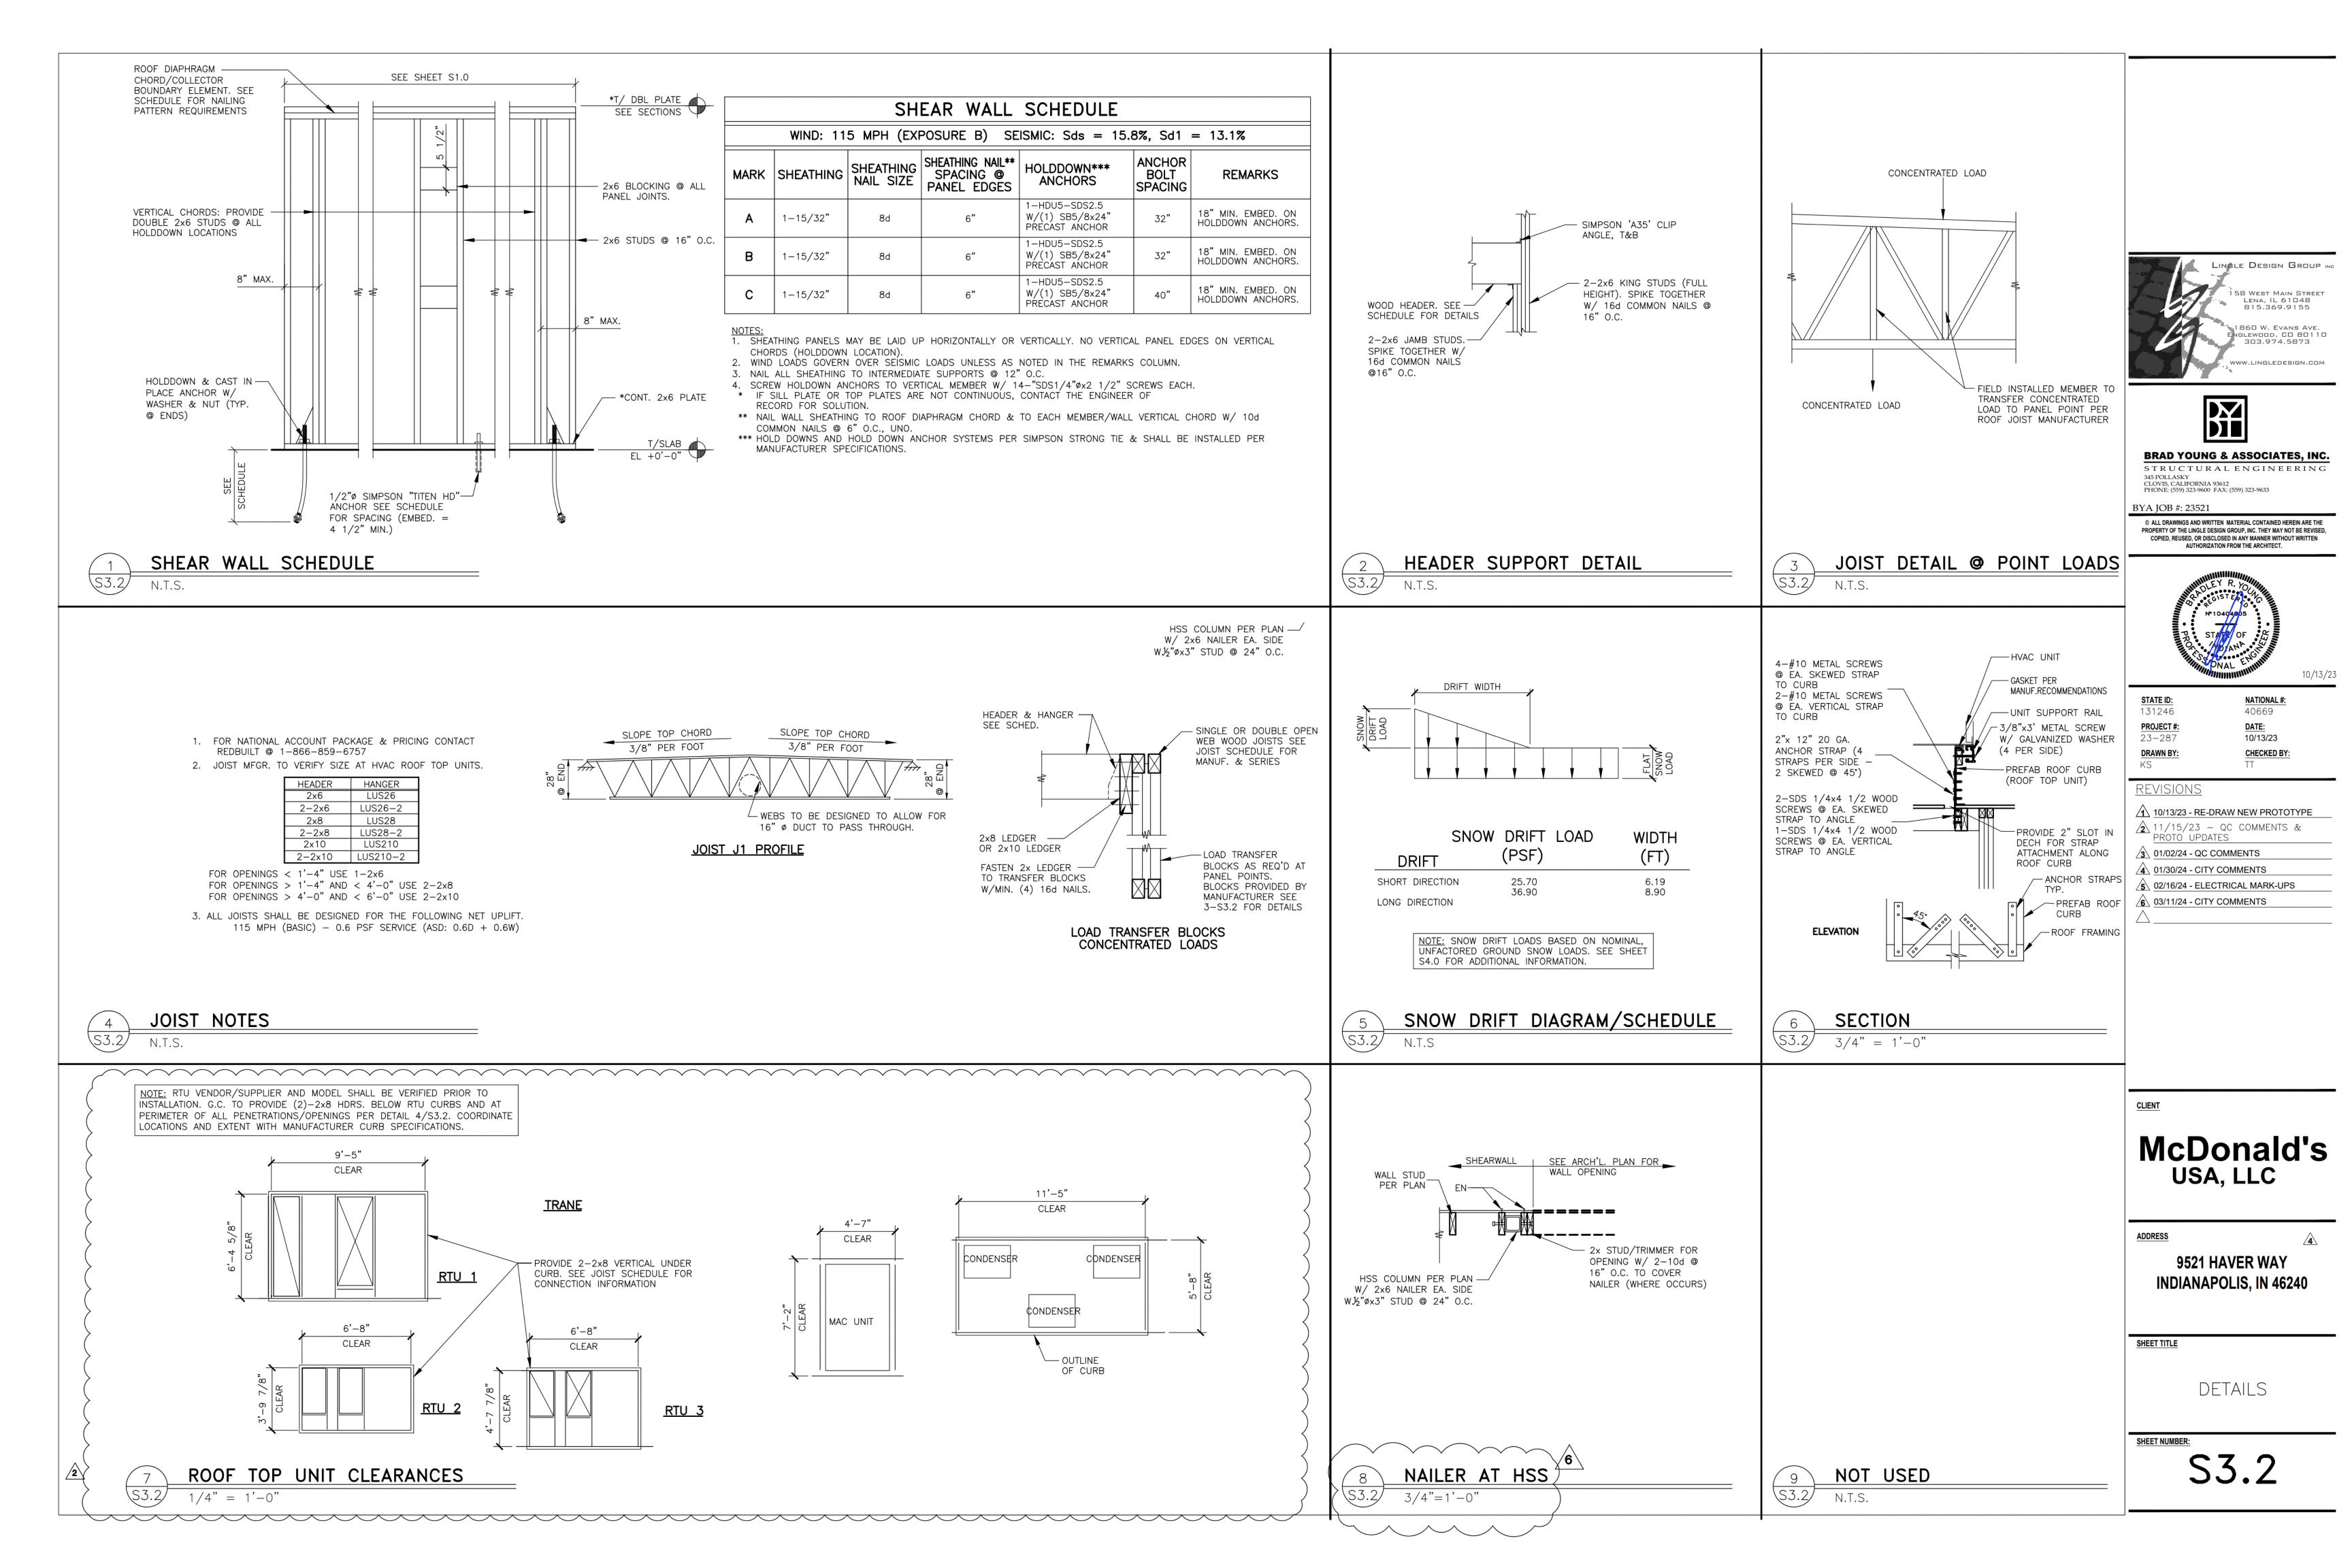

#### STRUCTURAL GENERAL NOTES:

#### DESIGN AND LOADING THE STRUCTURAL DESIGN OF THIS BUILDING WAS BASED ON THE DESIGN CRITERIA: A. BUILDING CODE: 2012 INTERNATIONAL BUILDING CODE

- B. FLOOR: LIVE LOAD: 100 PSF (NON-REDUCIBLE)
- C. ROOF: LIVE LOAD: 20 PSF
- DEAD LOAD: 20 PSF D. SNOW: GROUND LOAD, pg: 20 PSF FLAT ROOF LOAD, pf: 20 PSF IMPORTANCE FACTOR, Is: 1.0
- EXPOSURE FACTOR, Ce: 1.0 THERMAL FACTOR, C+: 1.0 SLOPE FACTOR, Cs: 1.0
- WIND:
  - BASIC DESIGN WIND SPEED (3-SECOND GUST), V: 115 MPH ALLOWABLE STRESS DESIGN WIND SPEED (3-SECOND GUST), VASD: 90 MPH RISK CATEGORY: II WIND EXPOSURE: B
- $GC_{0} = \pm 0.18$ PRESSURES PER ASCE 7-16 F. SEISMIC:
- RISK CATEGORY: II IMPORTANCE FACTOR: 1.00 SITE CLASS: D (ASSUMED)
- SS = 0.148, S1 = 0.082SDS = 0.158, SD1 = 0.031DESIGN CATEGORY: B
- PLYWOOD SHEAR WALLS (R = 6.5)STEEL SYSTEMS NOT SPECIFICALLY DETAILED FOR SEISMIC RESISTANCE (R = 3.0)Cs1: 0.024 (LONGITUDINAL DIRECTION) Cs2: 0.042 (TRANSVERSE DIRECTION) DESIGN BASE SHEAR = SEE CALCULATIONS
- ANALYSIS PROCEDURE: EQUIVALENT LATERAL FORCE PROCEDURE G. FLOOD LOAD: N/A
- H. SPECIAL LOADS: N/A
- I. RAIN LOADS: N/A

THE FOUNDATION DESIGN OF THIS BUILDING WAS BASED ON THE FOLLOWING CRITERIA:

- A. MINIMUM ALLOWABLE SOIL BEARING CAPACITY = 2,500 PSF.
- B. RECOMMENDED BY TERRACON IN THEIR REPORT #CK225133 DATED 01/13/2023 C. ANY FILL REQUIRED BELOW SLABS ON GRADE OR FOOTINGS SHALL BE COMPACTED AS REQUIRED BY THE SOILS REPORT NOTED IN ITEM #2.
- 2. ALL EXTERIOR FOOTINGS SHALL EXTEND BELOW THE MAXIMUM ANTICIPATED DEPTH OF
- 5. THE CONTRACTOR SHALL NOTIFY THE ARCHITECT OR ENGINEER OF RECORD IMMEDIATELY IN THE EVENT THAT THE SOILS CONDITIONS ENCOUNTERED VARY FROM THOSE SHOWN ON THE BORING LOGS.
- 4. ALL FOUNDATION EXCAVATIONS SHALL BE INSPECTED BY A SOILS TESTING LABORATORY PRIOR TO PLACEMENT OF CONCRETE.

#### CONCRETE AND REINFORCING

STANDARD 315 AND 315R.

- ALL CONCRETE SHALL BE IN ACCORDANCE WITH THE "AMERICAN CONCRETE INSTITUTE BUILDING CODE" (ACI 318) AND WITH "SPECIFICATIONS FOR STRUCTURAL CONCRETE FOR BUILDINGS" (ACI 301) LATEST EDITIONS.
- 2. ALL NORMAL WEIGHT CONCRETE (145 PCF) SHALL OBTAIN A MINIMUM 28 DAY COMPRESSIVE STRENGTH OF 3000 PSI (3500 PSI FOR SLABS).
- . ALL CONCRETE SUBJECT TO EXTERIOR EXPOSURE SHALL BE AIR ENTRAINED AS RECOMMENDED BY ACI 318.
- 4. TEST CYLINDERS SHALL BE MADE AND TESTED AS OUTLINED IN CHAPTER 16 OF ACI-301.
- 5. REINFORCING BARS SHALL BE DEFORMED BARS OF NEW BILLET STEEL CONFORMING TO ASTM A-615, GRADE 60. WELDED WIRE FABRIC SHALL CONFORM TO ASTM A-185. ALL REINFORCING AND ACCESSORIES SHALL BE DETAILED AND PLACED IN ACCORDANCE WITH ACI
- 6. PROVIDE ALL ACCESSORIES NECESSARY TO SUPPORT REINFORCEMENT AT POSITIONS SHOWN ON THE PLANS AND DETAILS. PLASTIC COATED ACCESSORIES SHALL BE USED IN ALL EXPOSED CONCRETE WORK.
- 7. THE GENERAL CONTRACTOR SHALL CHECK WITH ARCHITECTURAL, MECHANICAL AND ELECTRICAL DRAWINGS AND THE SUB-CONTRACTORS FOR OPENINGS, SLEEVES, ANCHORS, HANGERS, INSERTS, SLAB DEPRESSIONS AND OTHER ITEMS RELATED TO THE CONCRETE WORK AND SHALL ASSUME RESPONSIBILITY FOR THEIR PROPER LOCATION.

#### STRUCTURAL STEEL

- STRUCTURAL STEEL SHALL BE DETAILED, FABRICATED AND ERECTED IN CONFORMANCE WITH THE AISC360 "SPECIFICATION FOR STRUCTURAL STEEL". SEISMIC DESIGN OF STRUCTURAL STEEL STRUCTURES SHALL CONFORM TO AISC 341.
- STRUCTURAL STEEL SHALL CONFORM TO THE FOLLOWING ASTM SPECIFICATIONS:
- A. ANCHOR RODS F1554, GRADE 36
- B. HIGH STRENGTH STRUCTURAL BOLTS A325-N U.N.O.
- C. STRUCTURAL SHAPES (W) A992
- D. STRUCTURAL SHAPES (M, S, C, MC, PLATES) A36 E. STRUCTURAL SHAPES (HP) A572
- F. STRUCTURAL TUBING (HSS) A500 GRADE B G. STRUCTURAL ANGLES A36
- 3. ALL WELDING ELECTRODES SHALL BE E70-XX. ALL SHOP AND FIELD WELDING SHALL BE MADE IN ACCORDANCE WITH A.W.S. D1.1 "CODE FOR WELDING IN BUILDING CONSTRUCTION" AND SHALL BE MADE BY CERTIFIED WELDERS.

#### LAMINATED VENEER LUMBER (LVL)

- . ALL BEAMS SHALL BE MANUFACTURED WITH LAMINATED VENEER LUMBER AND WATERPROOF ADHESIVES.
- 2. SIZE, MANUFACTURER & SERIES OF ALL LVL MEMBERS SHALL BE AS SHOWN ON DRAWINGS.
- 3. ANY SUBSTITUTIONS MUST BE APPROVED IN WRITING BY ENGINEER OR ARCHITECT OF RECORD.
- 4. PROVIDE 3" MINIMUM BEARING OR AS SPECIFIED ON PLANS. REFER TO PLANS FOR FASTENING OF MULTIPLE PIECE BEAMS.

#### OPEN WEB WOOD JOISTS

- OPEN WEB WOOD JOISTS SHALL BE MANUFACTURED WITH MACHINE STRESS RATED TOP AND BOTTOM CHORDS. WEBS SHALL BE TUBULAR STEEL MEMBERS PER MANUFACTURERS' SPECIFICATIONS.
- 2. SIZE, MANUFACTURER & SERIES OF ALL OPEN WEB JOISTS SHALL BE AS SHOWN ON DRAWINGS. ANY SUBSTITUTIONS MUST BE APPROVED IN WRITING BY ENGINEER OR ARCHITECT OF RECORD.
- 3. PROVIDE 3 1/2" MINIMUM BEARING OR AS SPECIFIED ON PLANS. SHIM AS REQUIRED TO PROVIDE FULL BEARING AND LEVEL SUPPORT.
- 4. DO NOT CUT TOP OR BOTTOM CHORDS.
- 5. ALL HANGERS AND FRAMING CONNECTORS SHOWN ARE MANUFACTURED BY SIMPSON STRONG TIE. ANY SUBSTITUTIONS MUST BE APPROVED IN WRITING BY ENGINEER OR ARCHITECT OF RECORD.
- 6. REFER TO PLANS FOR WEB STIFFENER AND CONCENTRATED LOAD REQUIREMENTS.
- '. REFER TO MANUFACTURERS' INSTALLATION GUIDE FOR JOIST BRACING DURING ERECTION. REFER TO MANUFACTURERS' INSTALLATION GUIDE FOR JOIST BRIDGING REQUIREMENTS.

SAWN LUMBER

- ALL GRADES OF LUMBER INDICATED ON STRUCTURAL DRAWINGS SHALL BE RATED BY THE SOUTHERN PINE INSPECTION BUREAU (SPIB), OR THE WESTERN WOOD PRODUCTS ASSOCIATION (WWPA). LUMBER GRADES SHALL BE AS FOLLOWS, WITH A MAXIMUM MOISTURE CONTENT OF 19%:
- A. SOUTHERN PINE NO. 1.
- B. DOUGLAS FIR-LARCH NO. 1. C. HEM-FIR NORTH NO. 1
- BOLT HEADS AND NUTS BEARING ON WOOD SHALL BE PROVIDED WITH STANDARD CUT WASHERS. ALL WOOD IN CONTACT WITH CONCRETE OR MASONRY SHALL BE PRESSURE
- MINIMUM NAILED CONNECTIONS FOR WOOD FRAMING MEMBERS SHALL BE IN ACCORDANCE WITH THE LOCAL BUILDING CODE OR TABLE 2304.9.1 OF THE INTERNATIONAL BUILDING CODE IF NO OTHER CRITERIA IS GIVEN.
- CONNECTORS SHOWN ON THE DETAILS ARE MANUFACTURED BY SIMPSON. WRITTEN APPROVAL BY ENGINEER REQUIRED FOR SUBSTITUTIONS.

#### ROOF & WALL SHEATHING

- ALL SHEATHING SHALL CONFORM TO AMERICAN PLYWOOD ASSOCIATION (APA) DESIGN SPECIFICATIONS, LATEST EDITION. SHEATHING SHALL BE CONTINUOUS OVER THREE ADJACENT SPANS MINIMUM.
- WALL SHEATHING SHALL BE 15/32" (1/2" NOMINAL) APA RATED SHEATHING, EXPOSURE 32/16. ALL WALL SHEATHING SHALL BE FASTENED TO SUPPORTING MEMBERS W/ 8d COMMON NAILS @ 6" O.C. AT PANEL EDGES AND 12" O.C. AT INTERMEDIATED SUPPORTS,
- ROOF SHEATHING SHALL BE 23/32" (3/4" NOMINAL) APA RATED SHEATHING, EXPOSURE 1 48/24. ALL ROOF SHEATHING SHALL BE FASTENED TO SUPPORTING MEMBERS W/10d COMMON NAILS @ 6" O.C. AT PANEL EDGES, AND 12" O.C. AT INTERMEDIATE SUPPORTS.

#### LIGHT GAGE METAL FRAMING

- 16 GA. AND HEAVIER STUDS SHALL HAVE A MINIMUM YIELD STRESS OF 50,000 PSI. 18 GA. AND LIGHTER STUDS AND TRACKS SHALL HAVE A MINIMUM YIELD STRESS OF 33,000
- STUDS AND TRACKS SHALL BE 18 GA. MINIMUM U.N.O. THEY SHALL BE MANUFACTURED BY DIETRICH INDUSTRIES, INC. OR APPROVED EQUAL.
- PROVIDE DOUBLE STUDS FOR FULL HEIGHT OF WALL EACH SIDE OF ALL OPENINGS UNLESS OTHERWISE NOTED. WELD STUDS TO EACH OTHER WITH 1 1/2" LONG 1/8" FILLET WELDS AT 12" O.C. EACH SIDE. PROVIDE STUD TRACK AT EACH HEAD AND SILL.
- REFER TO PLANS AND DETAILS FOR CONNECTION OF STUD WALLS TO FOUNDATION, FLOOR OR ROOF.

#### SHOP DRAWINGS

SHOP DRAWING SUBMITTALS SHALL BE SUBMITTED ELECTRONICALLY.

- SHOP DRAWINGS SHALL BE REVIEWED BY CONTRACTOR TO VERIFY THAT SUBMITTAL IS COMPLETE PRIOR TO SUBMITTING TO ARCHITECT/ENGINEER.
- DRAWINGS CREATED BY THE ENGINEER OF RECORD CANNOT BE REPRODUCED AND/OR USED AS A SHOP DRAWING SUBMITTAL. SHOP DRAWING SUBMITTALS SHALL INCLUDE THE FOLLOWING:
- A. CONCRETE MIX DESIGN
- B. FOUNDATION REINFORCING BARS
- C. STRUCTURAL STEEL
- OPEN WEB JOISTS AND CALCULATIONS ROOF SHEATHING
- TRELLIS SYSTEM & CALCULATIONS
- G. LAMINATED VENEER LUMBER (LVL) H. SAWN LUMBER AND CONNECTORS

#### SPECIAL INSPECTIONS

- SPECIAL INSPECTIONS SHALL BE PERFORMED IN ACCORDANCE WITH SECTION 1705 OF IBC AND THE OWNER SHALL EMPLOY ONE OR MORE SPECIAL INSPECTORS TO PROVIDE INSPECTIONS DURING CONSTRUCTION ON THE TYPES OF WORK LISTED UNDER SECTION 1705. THE FOLLOWING AREAS OF WORK REQUIRE SPECIAL INSPECTIONS IN ACCORDANCE WITH THE LISTED 2021 INTERNATIONAL BUILDING CODE SECTIONS/LOCATIONS:
- A. SOILS SECTION 1705.6 PER TABLE 1705.6
- B. CONCRETE SECTION 1705.3 PER TABLE 1705.3 C. STEEL - SECTION 1705.2 (SEE AISC 360-16)
- D. WOOD SECTION 1705.5

## **MISCELLANEOUS**

- ALL DIMENSIONS ON STRUCTURAL DRAWINGS TO BE CHECKED AGAINST ARCHITECTURAL. MECHANICAL AND ELECTRICAL DRAWINGS BY THE GENERAL CONTRACTOR AND ANY DISCREPANCIES ARE TO BE REPORTED TO THE ARCHITECT IMMEDIATELY.
- THE CONTRACTOR SHALL ASSUME RESPONSIBILITY, UNRELIEVED BY REVIEW OF SHOP DRAWINGS OR PERIODIC OBSERVATION OF CONSTRUCTION, FOR COMPLIANCE WITH THE CONTRACT DOCUMENTS. FOR FABRICATION PROCESSES AND CONSTRUCTION TECHNIQUES. AND FOR SAFE CONDITIONS ON THE JOB SITE.
- 3. DO NOT SCALE THE DRAWINGS.

#### **VENEER TIE REQUIREMENTS:**

- FOR SEISMIC DESIGN CATEGORIES 'A' THROUGH 'C' WITH ULTIMATE WIND SPEED LESS THAN 140 MPH, USE THE FOLLOWING: VENEER TIES W/ WIRE SIZE (W2.8 OR 3/16"ø) SPACED 16" O.C. VERTICALLY AND 32" HORIZONTALLY. ADDITIONAL TIES ALONG ALL OPENINGS GREATER THAN 16" ARE REQUIRED TO BE LOCATED WITHIN 12" OF OPENING AND SPACED 36" O.C. MAX. AROUND OPENING PERIMETER. (HOHMANN & BARNARD VBT-VEE-BYNA TIE WITH DW10-HS ANCHOR PLATE OR EQUAL).
  - FOR SEISMIC DESIGN CATEGORIES 'D' THROUGH 'F' WITH WIND ULTIMATE SPEED
  - LESS THAN 140 MPH, USE THE FOLLOWING: - MEET THE REQUIREMENTS OF '1' WITH THE FOLLOWING CHANGES: VENEER TIES ——<del>TO BE SPACED 16" O.C. VERTICALLY AND 24" O.C. HORIZONTALLY. PROVIDE A</del>
  - CONTINUOUS WIRE SIZE (W2.8 OR 3/16") SPACED 16" O.C. VERTICALLY WITHIN VENEER MORTAR JOINT TO ENGAGE VENEER TIES.
- (HOHMANN & BARNARD VBT VEE—BYNA TIE AND SEISMICLIP INTERLOCK ——SYSTEM (S.I.S.) — SEISMIC CLIP WITH DW10—HS ANCHOR PLATE OR EQUAL)
- FOR ULTIMATE WIND SPEED OF 140 MPH THROUGH 170 MPH, USE THE FOLLOWING SPACING IN CONJUNCTION WITH THE REQUIREMENTS OF THE SEISMIC DESIGN CATEGORY (SEE 1 AND 2):
- ADDITIONAL TIES ALONG ALL OPENINGS GREATER THAN 16" ARE REQUIRED TO BE LOCATED WITHIN 12" OF THE OPENING AND SPACED 24" O.C. MAX. AROUND — OPENING PERIMETER.



VENEER TIE REQUIREMENTS


LINGLE DESIGN GROUP INC 158 WEST MAIN STREET 815.369.9155 1860 W. EVANS AVE. 303.974.5873 WW.LINGLEDESIGN.COM



BYA IOB #: 23521

CLOVIS, CALIFORNIA 93612 PHONE: (559) 323-9600 FAX: (559) 323-9633

© ALL DRAWINGS AND WRITTEN MATERIAL CONTAINED HEREIN ARE THE PROPERTY OF THE LINGLE DESIGN GROUP, INC. THEY MAY NOT BE REVISED. COPIED. REUSED. OR DISCLOSED IN ANY MANNER WITHOUT WRITTEN AUTHORIZATION FROM THE ARCHITECT

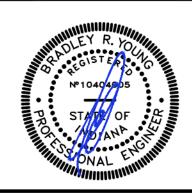

STATE ID: NATIONAL #: 131246 40669 PROJECT #

23-287 10/13/23 CHECKED BY DRAWN BY:

#### <u>REVISIONS</u>

- √1 \ 10/13/23 RE-DRAW NEW PROTOTYPE 11/15/23 - QC COMMENTS & PROTO UPDATES
- 3 01/02/24 QC COMMENTS
- 4 01/30/24 CITY COMMENTS
- 5 02/16/24 ELECTRICAL MARK-UPS
- 6 03/11/24 CITY COMMENTS

## McDonald's USA, LLC

**ADDRESS** 

9521 HAVER WAY **INDIANAPOLIS, IN 46240** 

SHEET TITLE

STRUCTURAL NOTES

SHEET NUMBER: